
Appendix 2 - Floor Plans Pavilion AV RFP Sheet 1 of 8

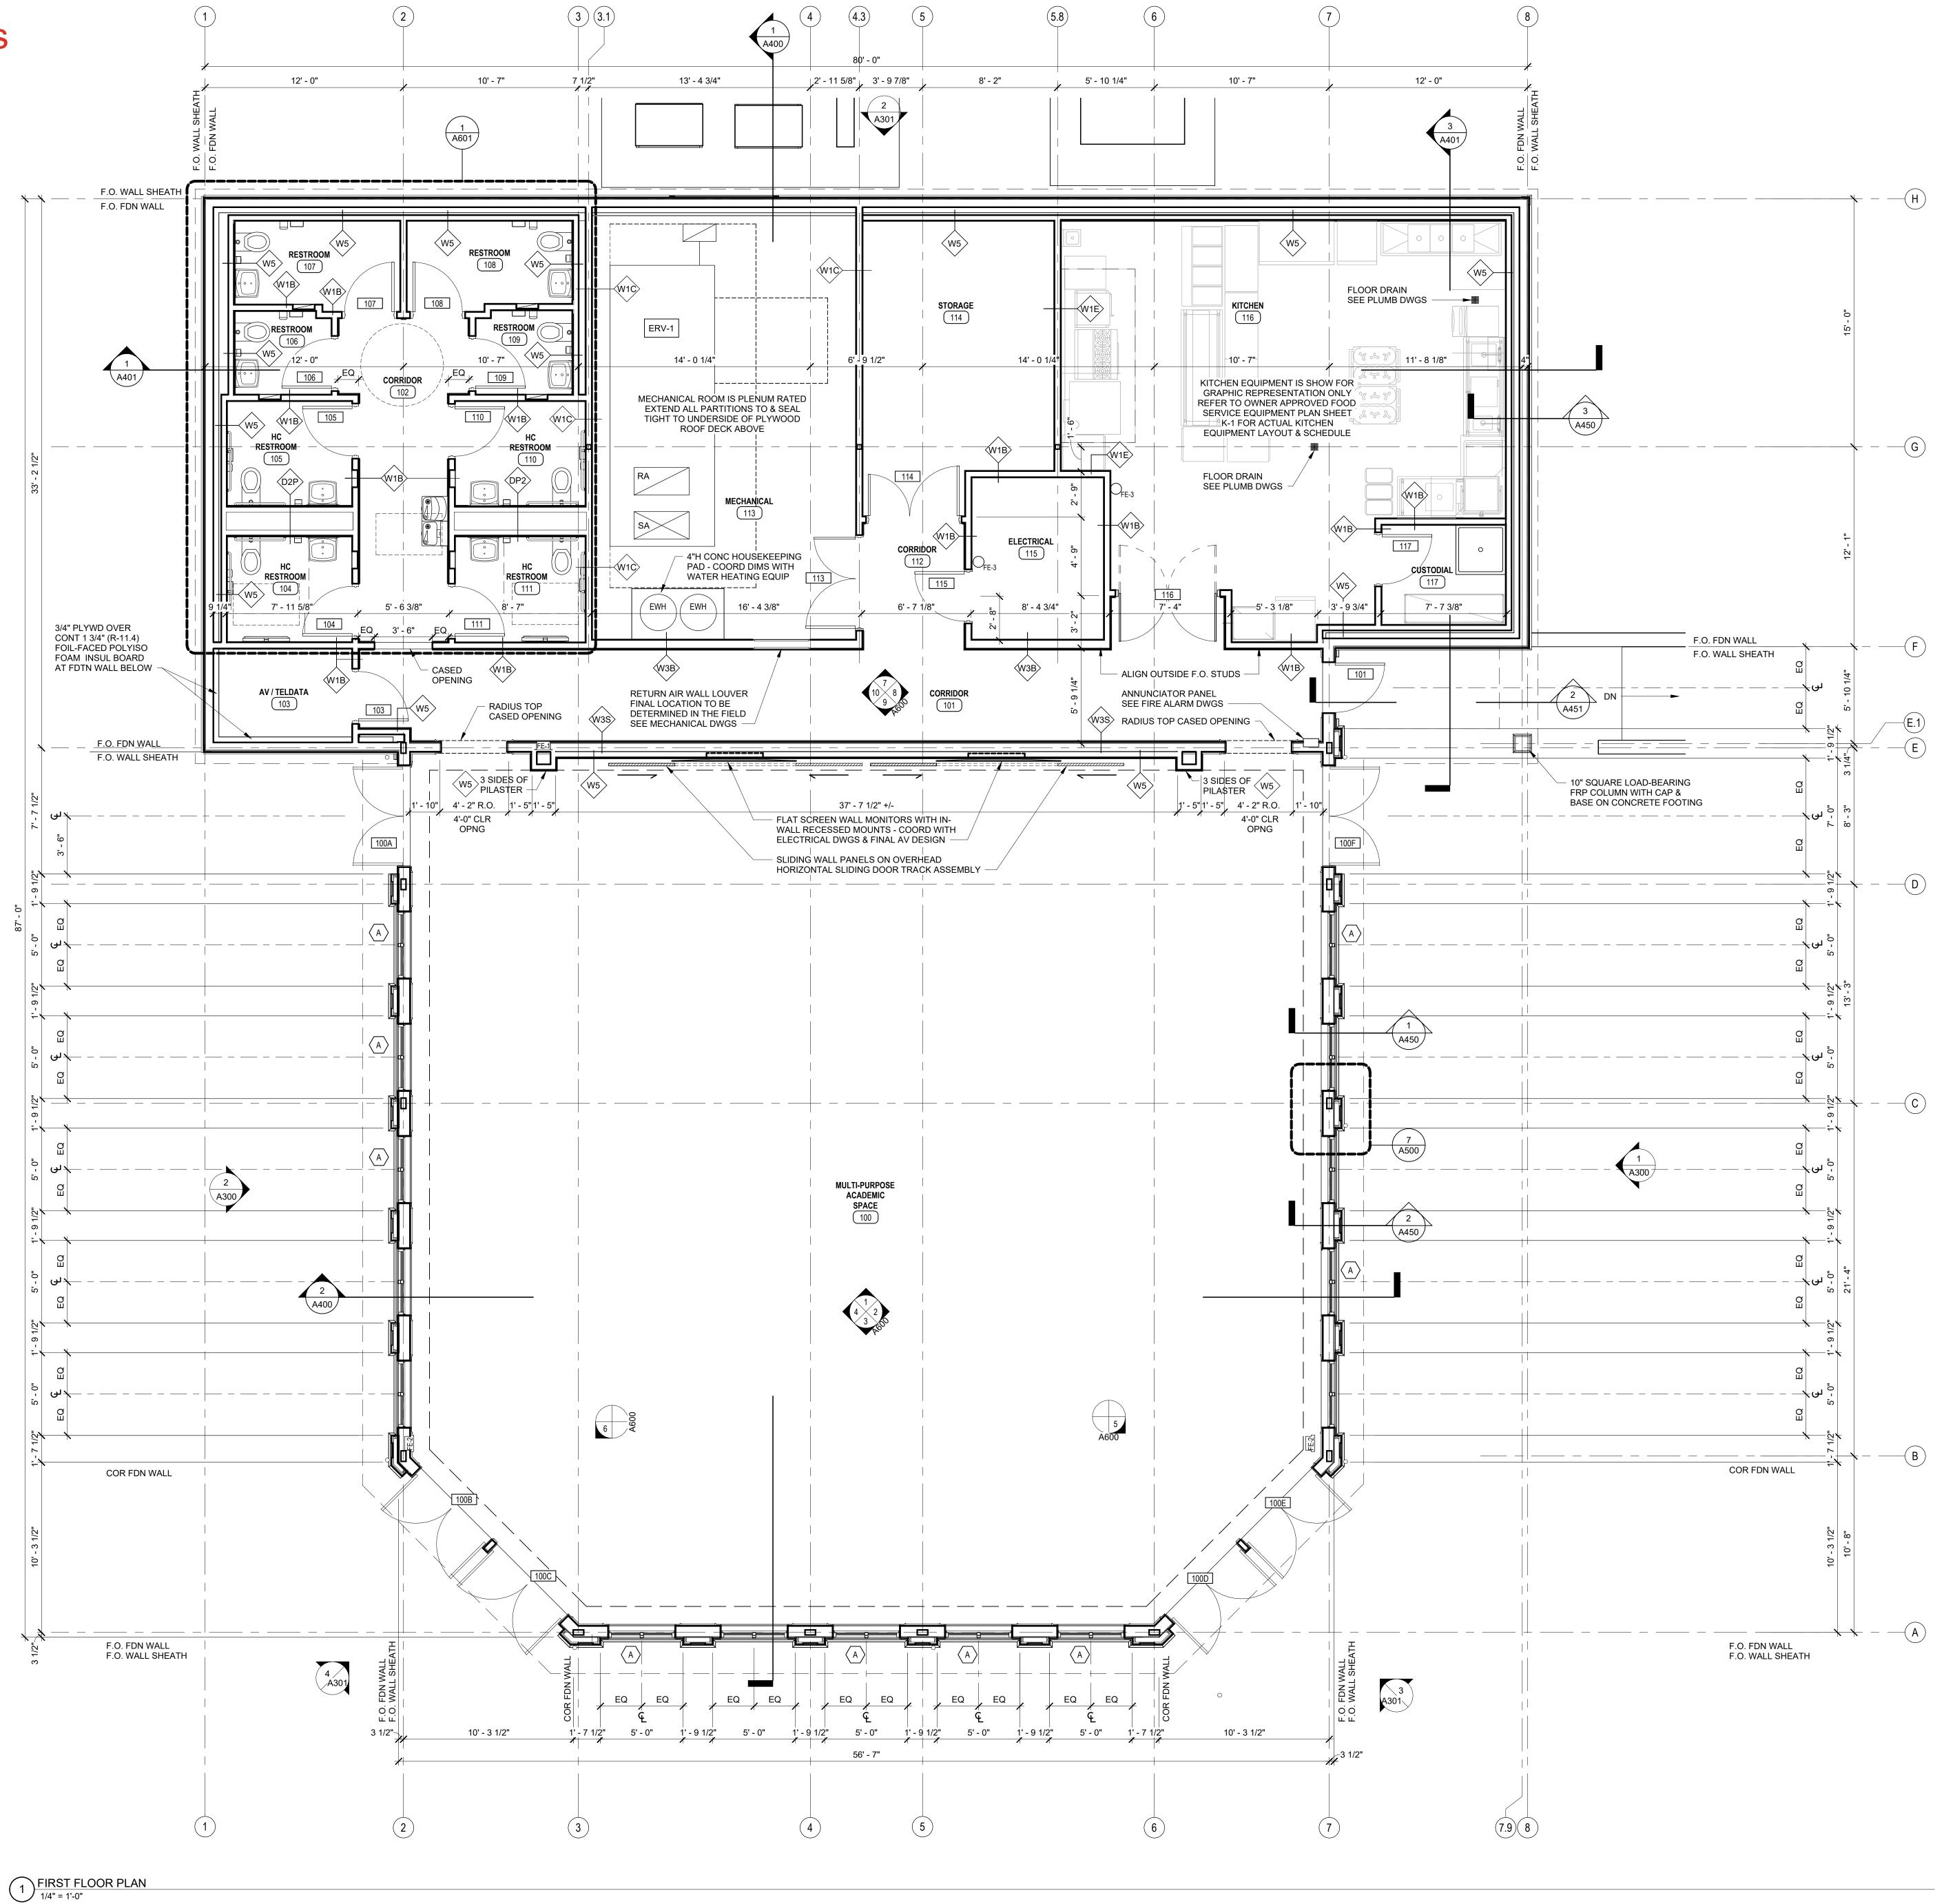







NEW STUDENT CENTER "PAPITTO" PAVILLION

NEWPORT, RHODE ISLAND

SALVE REGINA UNIVERSITY

NO DATE DESCRIPTION

© COPYRIGHT 2025
DBVW ARCHITECTS, INC.
UNAUTHORIZED USE IS PROHIBITED

DATE: 4/16/25


DRAWN BY: CDA

JOB NO: 2319

SCALE: 1/4" = 1'-0"

FIRST FLOOR PLAN

Sheet 2 of 8

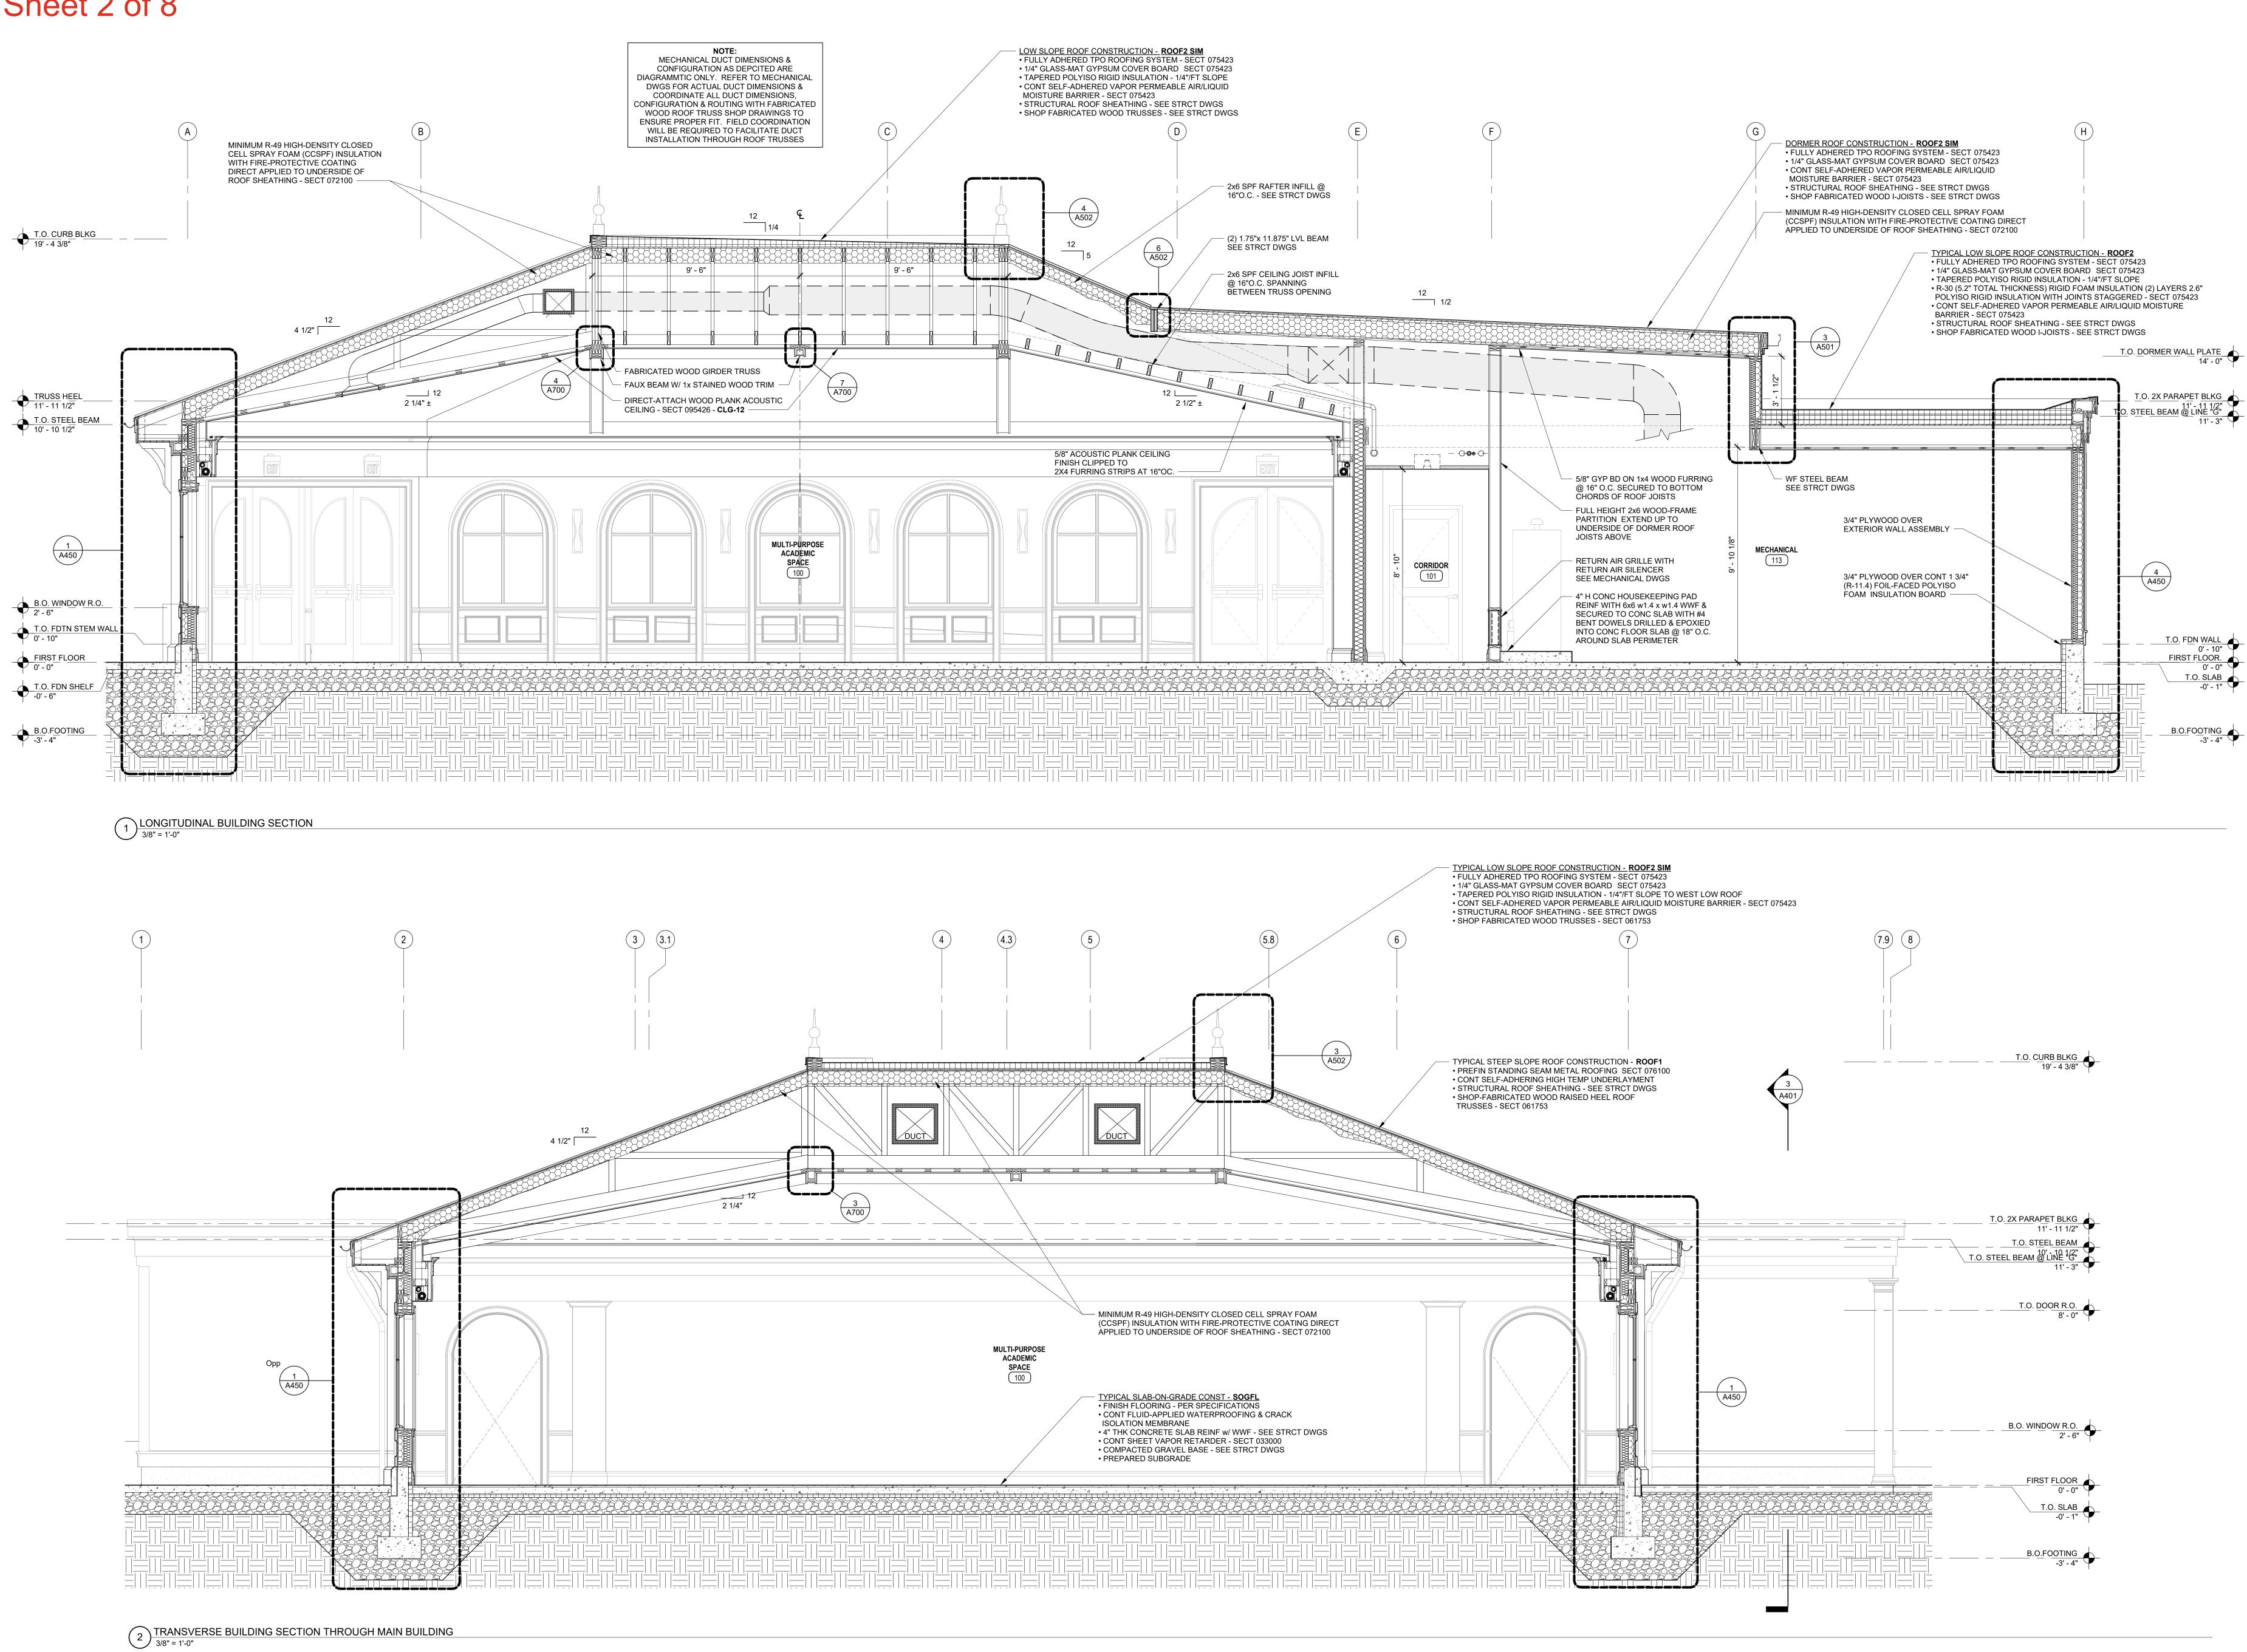







NEW STUDENT CENTER "PAPITTO" **PAVILLION**

NEWPORT, RHODE ISLAND

SALVE REGINA UNIVERSITY


NO DATE DESCRIPTION

© COPYRIGHT 2025 DBVW ARCHITECTS, INC. UNAUTHORIZED USE IS PROHIBITED DATE: 4/16/25

DRAWN BY: Author JOB NO: 2319 SCALE: 3/8" = 1'-0"


BUILDING SECTIONS

A400

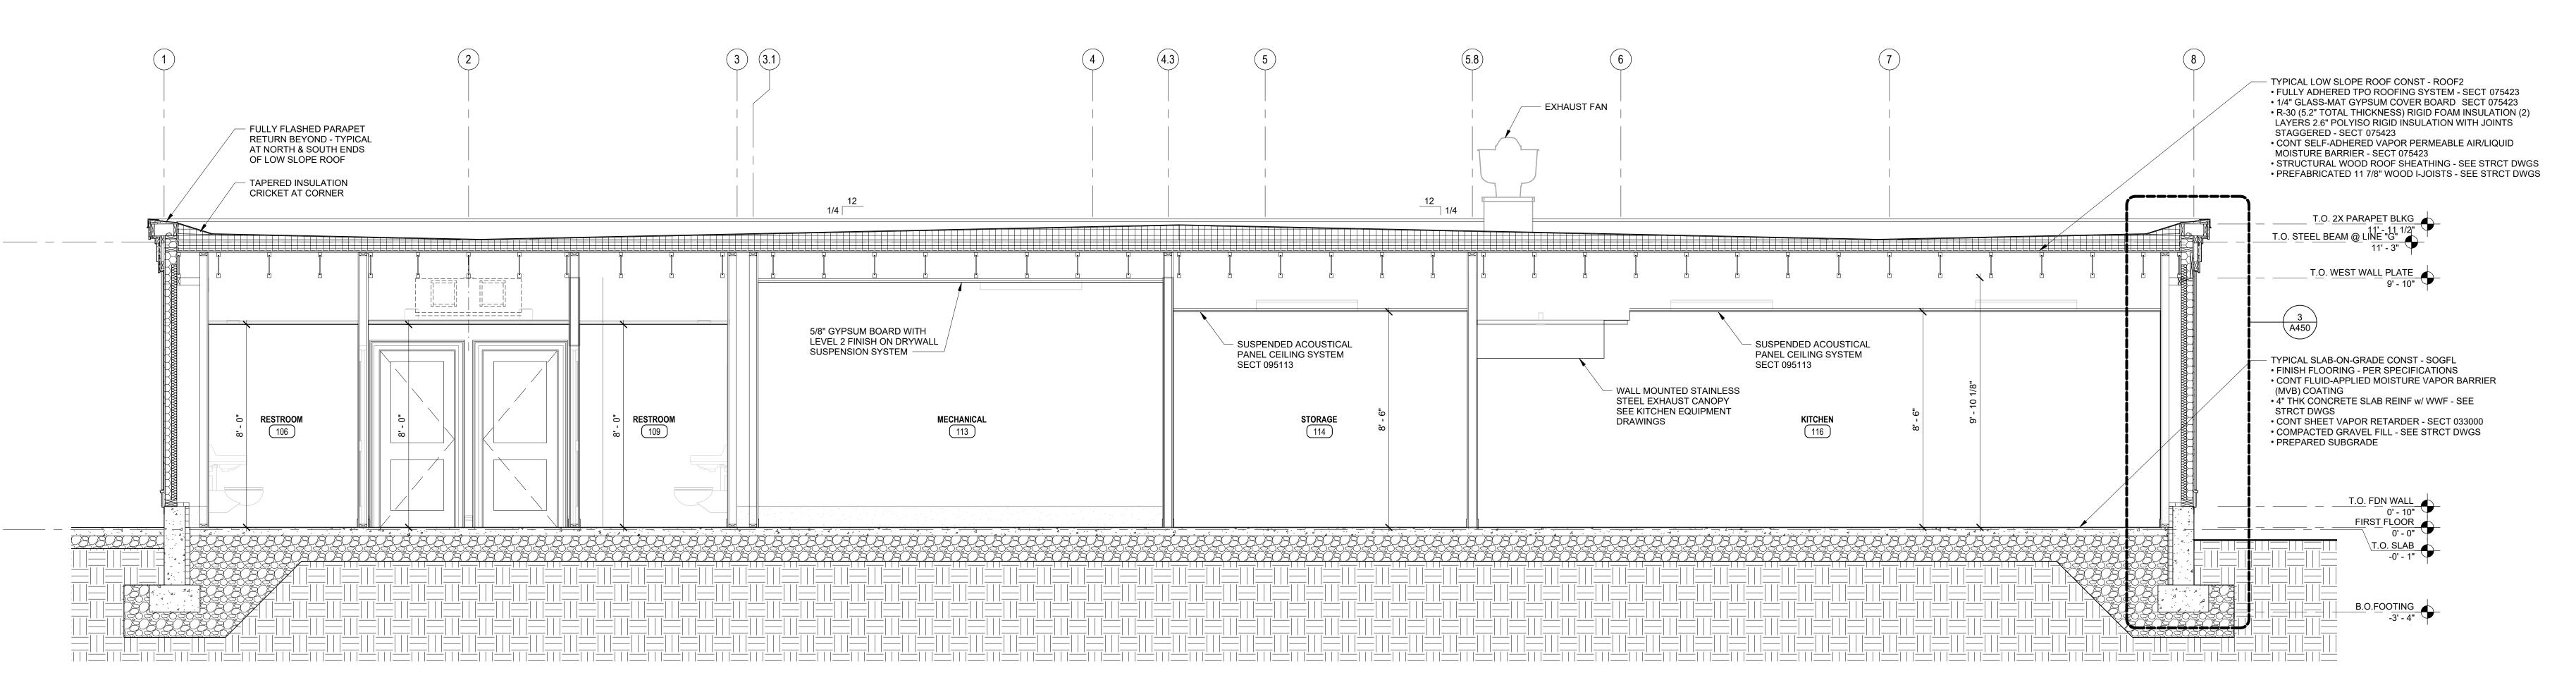


TRANSVERSE BUILDING SECTION THROUGH WEST SIDE BUILDING BAR

3/8" = 1'-0"

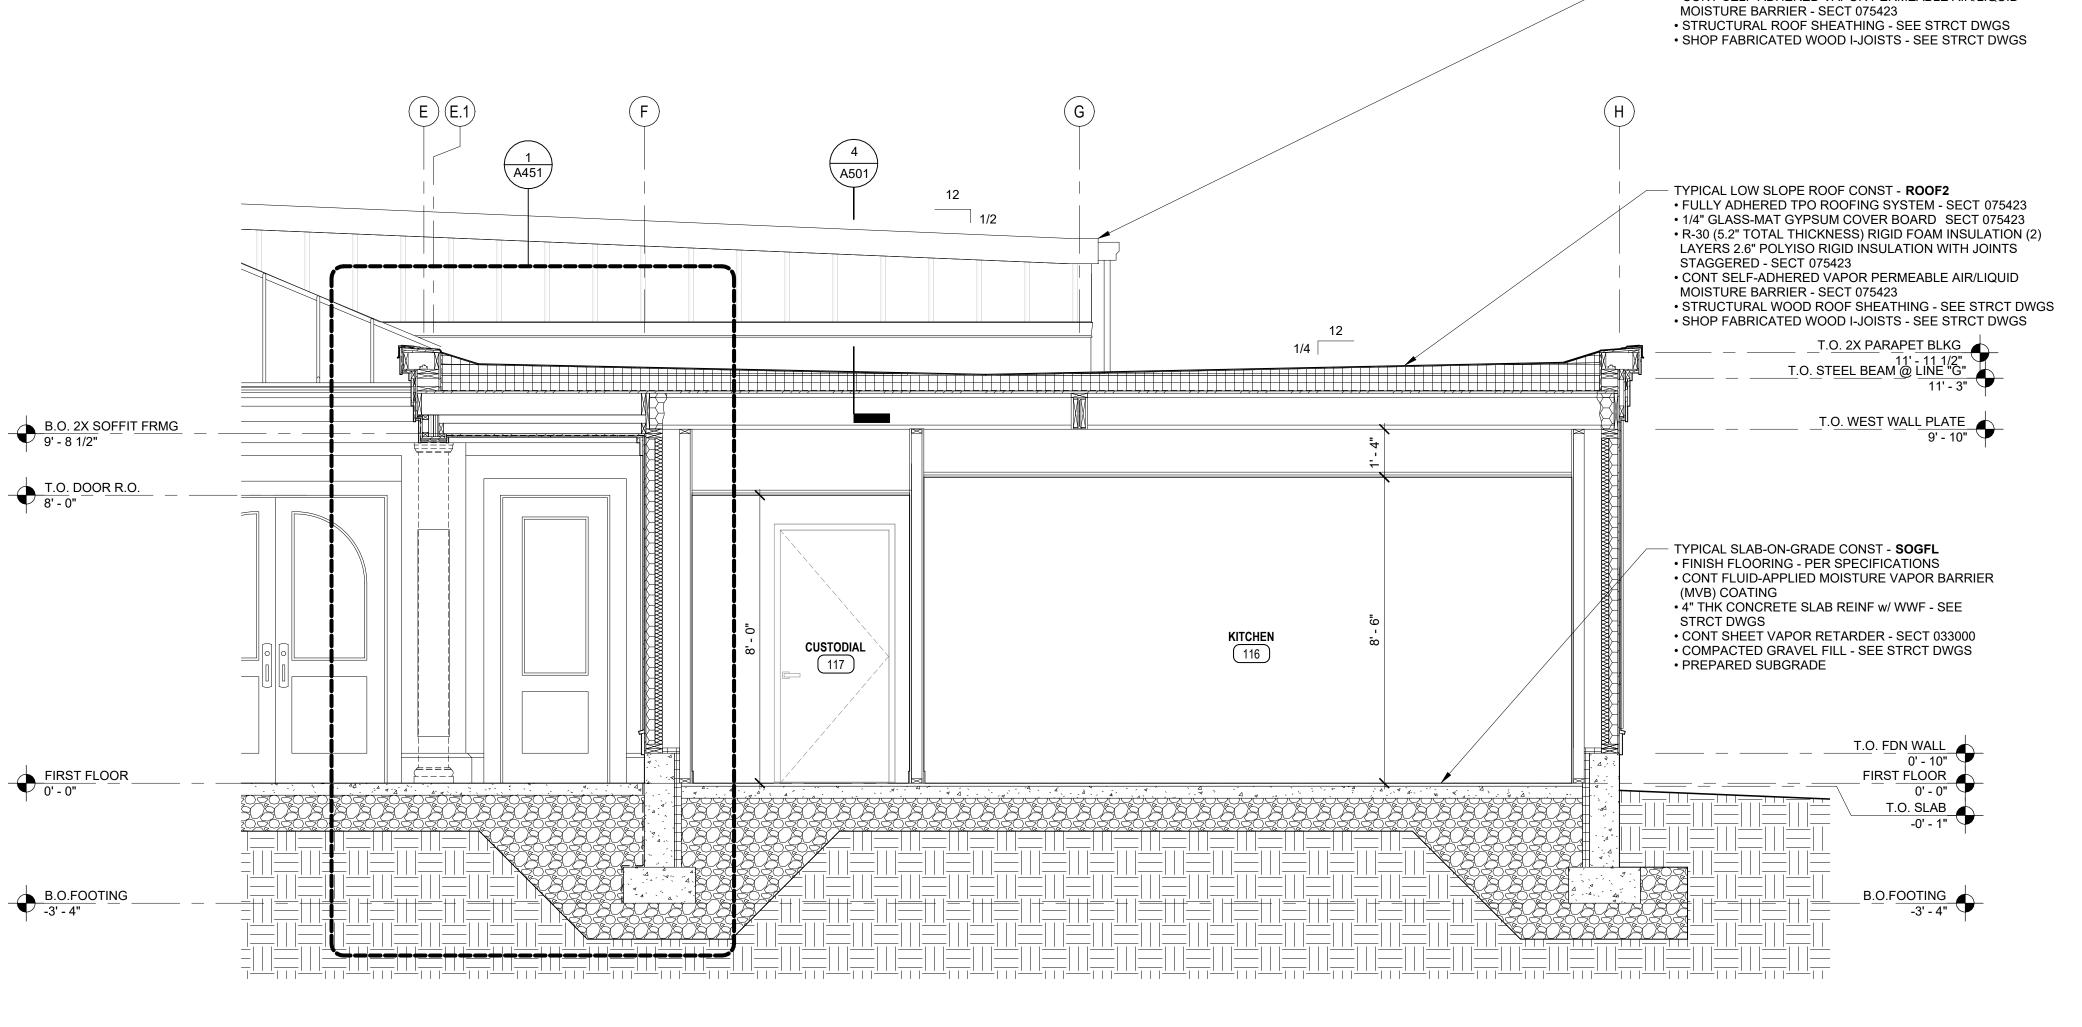

3 BUILDING SECTION THROUGH EAST SIDE BUILDING BAR & ENTRY
3/8" = 1'-0"



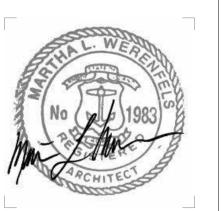



DORMER ROOF CONST - SIM TO ROOF1

FULLY ADHERED TPO ROOFING SYSTEM - SECT 075423
CONT SELF-ADHERED VAPOR PERMEABLE AIR/LIQUID

NEW STUDENT CENTER "PAPITTO" PAVILLION

NEWPORT, RHODE ISLAND

SALVE REGINA UNIVERSITY

NO DATE DESCRIPTION

© COPYRIGHT 2025
DBVW ARCHITECTS, INC.
UNAUTHORIZED USE IS PROHIBITED


DATE: 4/16/25


DRAWN BY: Author

JOB NO: 2319 SCALE: 3/8" = 1'-0"

BUILDING SECTIONS

Sheet 4 of 8

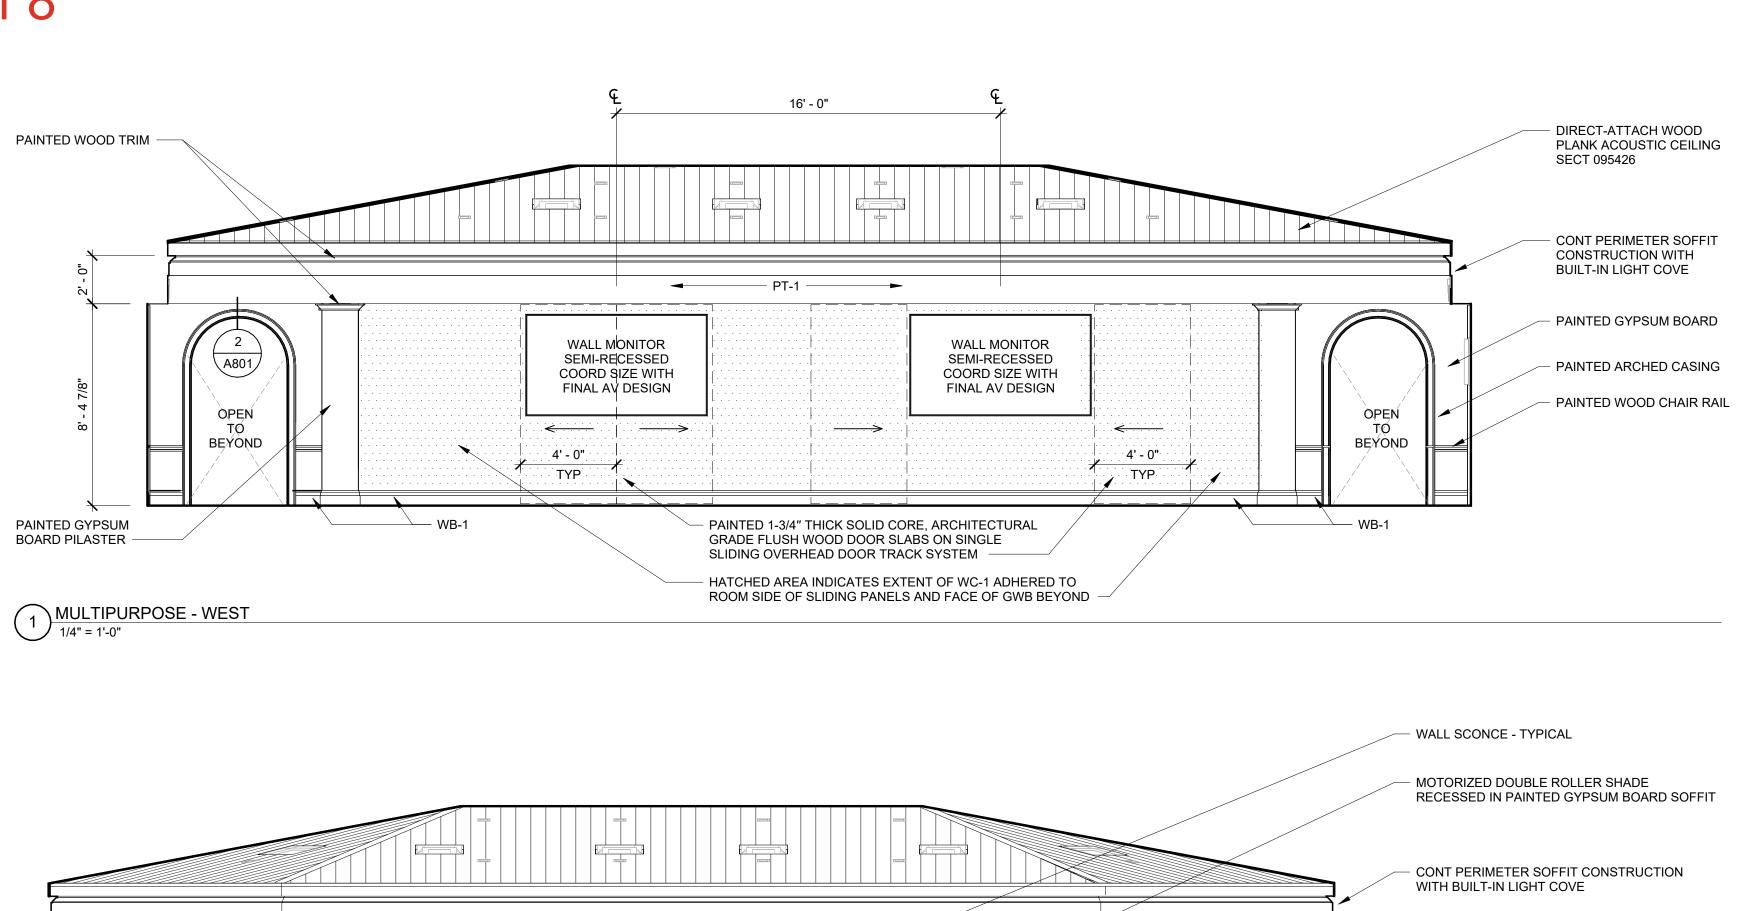

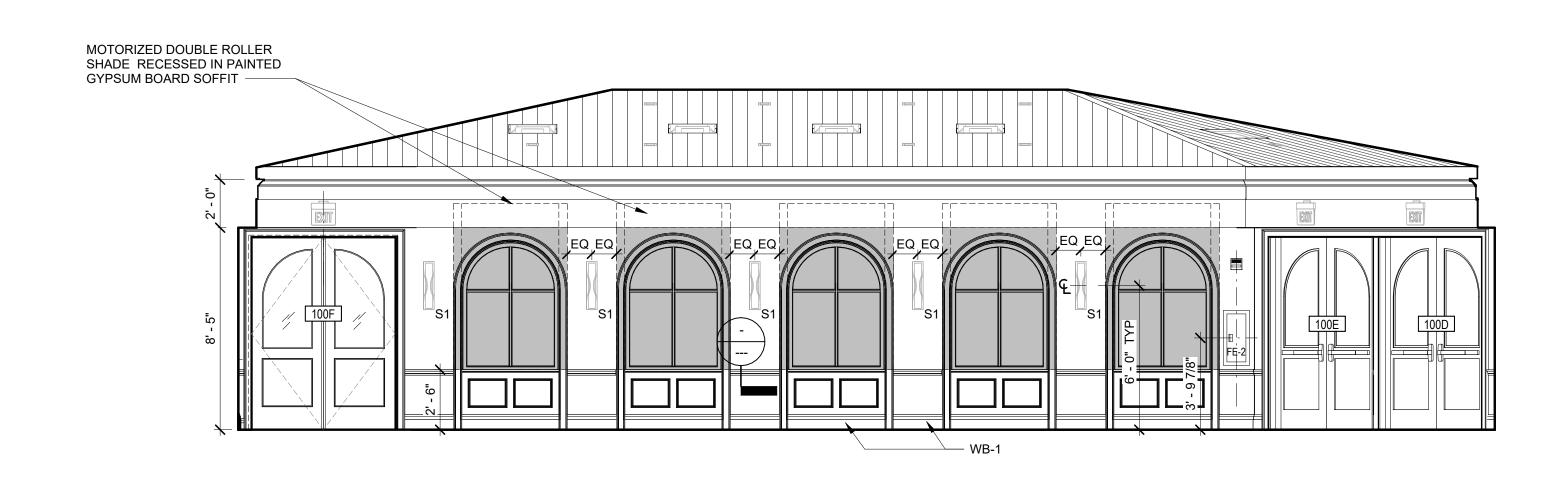

DIRECTATTACH WOOD PLANK ACOUSTIC CEILING - SECT 09508

MOTORIZED DOUBLE ROLLER SHADE RECESSED IN PAINTED GYPSUM BOARD SOFFIT

WALL SCONCE

WALL SCONCE

1000

1000

PAINTED GYPSUM BOARD WITH PAINTED WOOD PANEL TRIM - TYPICAL AT WINDOWS

4 MULTIPURPOSE - SOUTH
1/4" = 1'-0"

2 MULTIPURPOSE - NORTH
1/4" = 1'-0"



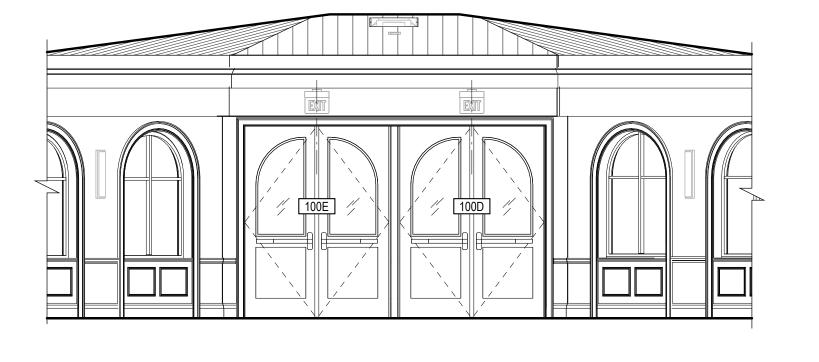


100C 100B


— PAINTED WOOD CHAIR RAIL

5 MULTIPURPOSE - NORTHEAST ENTRANCE

6 MULTIPURPOSE - SOUTHEAST ENTRANCE


1/4" = 1'-0"

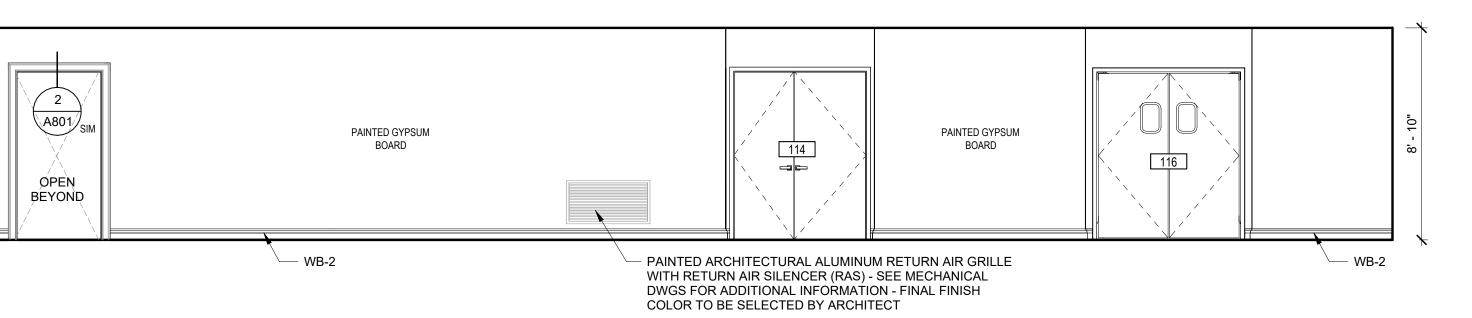


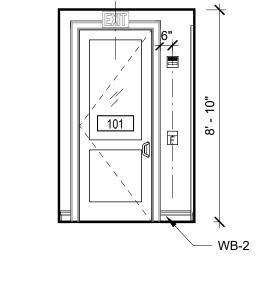


7 CORRIDOR 101 - WEST
1/4" = 1'-0"



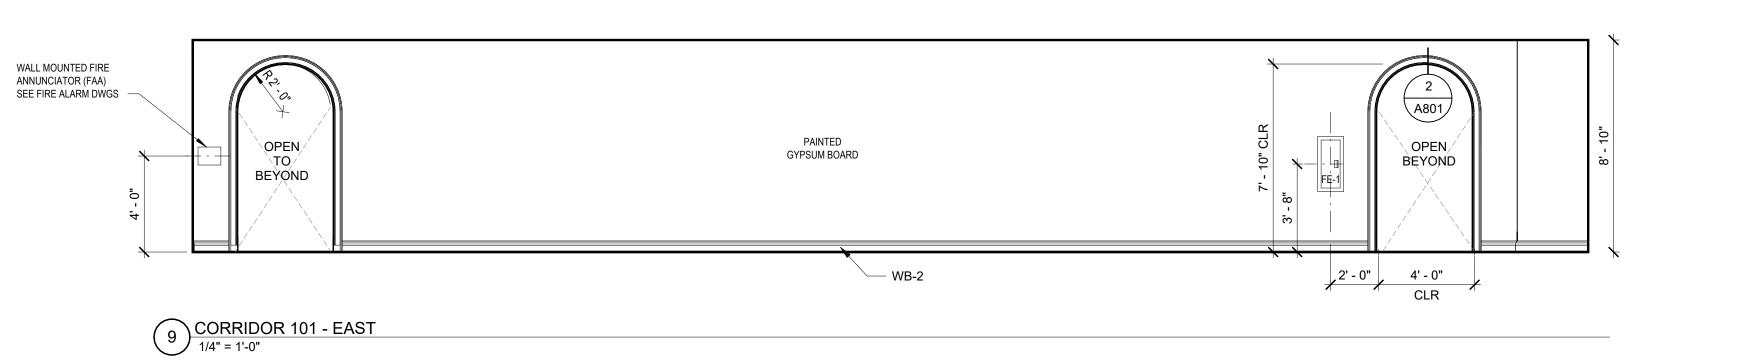

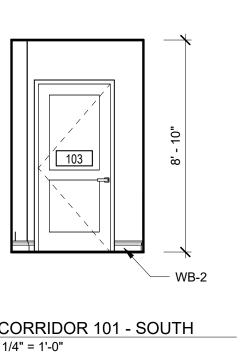



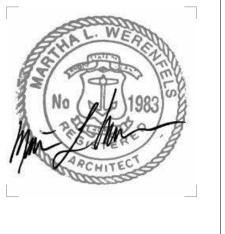



NEW STUDENT CENTER "PAPITTO" PAVILLION

NEWPORT, RHODE ISLAND

SALVE REGINA UNIVERSITY

NO DATE DESCRIPTION

NO DATE DESCRIPTION

© COPYRIGHT 2025
DBVW ARCHITECTS, INC.
UNAUTHORIZED USE IS PROHIBITED

DATE: 4/16/25

DRAWN BY: Author

JOB NO: 2319

SCALE: 1/4" = 1'-0"

INTERIOR

ELEVATIONS

UNDERSIDE OF WOOD DECK OR STRUCTURE HANGER WIRE -PREFIN DIRECT-HUNG METAL CEILING SUSPENSION SYSTEM -1x4 WOOD FURRING STRIPS @ 16" O.C. -LAY-IN ACOUSTICAL PANELS SEE SHEET A901 FOR LOCATIONS -(1) LAYER 5/8" TYPE X GYPSUM BOARD — CONT PREFIN METAL EDGE MOLDING -WOOD I-JOISTS OR OTHER EXTERIOR WALL OR INTERIOR WOOD STRUCTURE PARTITION - PER SCHEDULE -SEE FRAMING PLANS -CLG-1 DIRECT-ATTACH GYPSUM BOARD CEILING **│ LAY-IN ACOUSTICAL PANEL CEILING** CLG-3 24" x 24" PANELS CLG-3A LAY-IN ACOUSTICAL PANEL CEILING 24" x 48" PANELS REFER TO CEILING SYSTEM MANUFACTURER'S INSTALLATION UNDERSIDE OF WOOD DECK OR STRUCTURE INSTRUCTIONS & SPECIFICATIONS FOR SPECIFIC INSTALLATION DETAILS FABRICATED WOOD ROOF TRUSSES PRE-ENGINEERED HEAVY VENEER LINEAR-PLANKS ——/ DUTY WALL-TO-WALL 2x4 WOOD FURRING @ 16" O.C. SCREWED TO BOTTOM CHORDS METAL CEILING SUSPENSION SYSTEM -OF WOOD ROOF TRUSSES — 2 1/2" UNFACED SOUND ATTENUATION BATT INSULATION — PLANK CLIP SCREWED DIRECTLY TO WOOD FURRING — (1) LAYER 5/8" TYPE X ACOUSTICALLY ÈNHANCED GYPSUM BOARD — REFER TO SPECIFIC CEILING DETAILS FOR PERIMETER TRIM CONT L-SHAPED ANGLE MOLDING FOR MOUNTING AT SAME ELEVATION EXTERIOR WALL OR INTERIOR AS FACE OF GRID — PARTITION - PER SCHEDULE -INTERIOR PARTITION - PER SCHEDULE CLG-8 SUSPENDED WALL-TO-WALL GYPSUM BOARD CEILING DIRECT-ATTACH WOOD PLANK ACOUSTIC CEILING

2 CEILING TYPES 1 1/2" = 1'-0"

1 PARTITION TYPES
1 1/2" = 1'-0"

GENERAL PARTITION NOTES

1. ALL INTERIOR PARITIONS SHALL EXTEND FROM TOP OF CONCRETE FLOOR SLAB UP TO UNDERSIDE OF WOOD ROOF DECK OR STRUCTURE ABOVE. FURNISH AND INSTALL ALL BLOCKING AND BRACING AS REQUIRED FOR ADEQUATE SUPPORT OF ALL

2. FURNISH AND INSTALL SEMI-RIGID STONE WOOL SOUND ATTENUATION BATT (SAB) INSULATION TO COMPLETELY FILL STUD CAVITIES AT ALL INTERIOR PARTITIONS. INSULATION SHALL EXTEND FROM BASE OF PARTITION TO TOP OF PARTITION AT UNDERSIDE OF WOOD ROOF DECK OR STRUCTURE ABOVE.


3. FURNISH AND INSTALL CONTINUOUS ACOUSTICAL JOINT SEALANT AT ENTIRE PERIMETER OF MECHANICAL ROOM #113, INCLUDING BUT NOT LIMITED TO ALL PARTITION-TO-PARTITION, PARTITION-TO-CEILING AND PARTITION-TO-FLOOR JUNCTURES. REFER TO SPECIFICATION SECTION 092900 FOR ADDITIONAL INFORMATION.


4. REFER TO CEILING TYPES FOR FURTHER INFORMATION REGARDING REQUIREMENTS FOR THE INTEGRATION OF CEILING SYSTEMS WITH PARTITION AND WALL ASSEMBLIES. CONTRACTOR TO COORDINATE CORRECT SEQUENCING OF WALL AND CEILING SYSTEM COMPONENTS TO CREATE COMPLIANT FIRE RATED WALL ASSEMBLIES AND / OR ACOUSTIC WALL ASSEMBLIES AS INDICATED.

5. REFER TO PARTITION TYPES FOR ADDITIONAL SOUND ATTENUATION REQUIREMENTS AT PARTITIONS. ALSO SEE PROJECT SPECIFICATIONS FOR SOUND ISOLATION REQUIREMENTS AND SOUND PROOFING REQUIREMENTS OF ALL WALL PENETRATIONS AND WALL MOUNTED EQUIPMENT, INCLUDING BUT NOT LIMITED TO MECHANICAL DUCTWORK AND EQUIPMENT, PLUMBING LINES AND FIXTURES, ELECTRICAL EQUIPMENT AND FIRE PROTECTION LINES.

6. FURNISH AND INSTALL 3/4" THICK FIRE-TREATED PLYWOOD BACKER BOARDS AT ALL EQUIPMENT REQUIRING SUCH BACK-UP FOR MOUNTING INCLUDING BUT NOT LIMITED TO ELECTRIC PANELS, ELECTRIC EQUIPMENT, ELECTRIC METERS, AUDIO VISUAL AND DATA RACKS, ETC.). BACKER BOARDS SHALL BE PAINTED MATTE BLACK. REFER TO SPECIFICATION SECTION 061000 FOR ADDITIONAL INFORMATION.




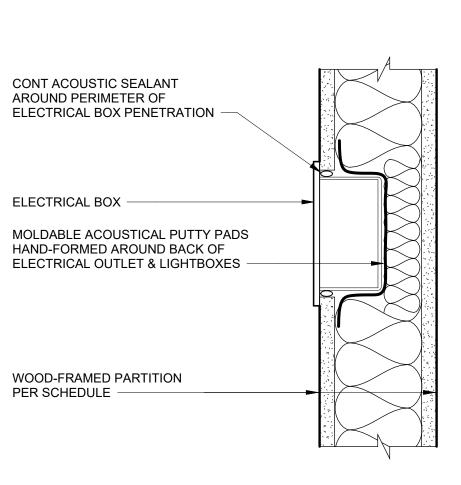

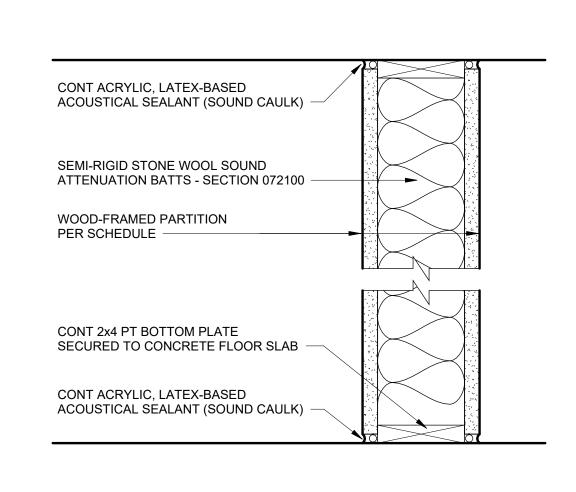

3 TYPICAL ACOUSTICAL PUTTY PAD DETAIL
3" = 1'-0"



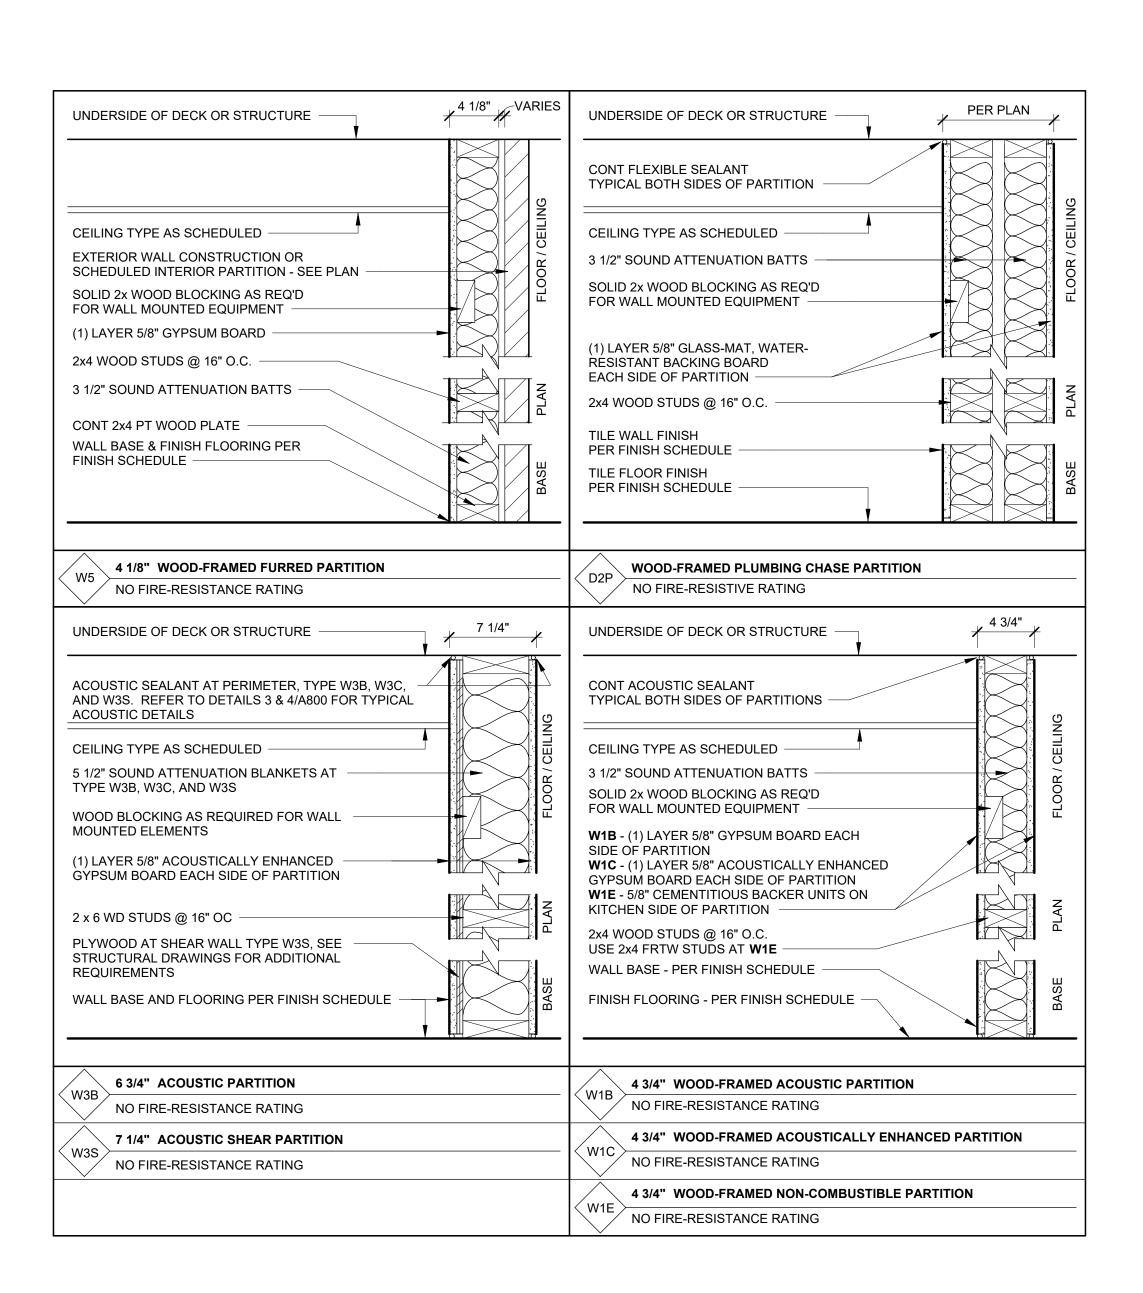



NEW STUDENT CENTER "PAPITTO" PAVILLION

NEWPORT, RHODE ISLAND

SALVE REGINA UNIVERSITY


NO DATE DESCRIPTION


_____ © COPYRIGHT 2025 DBVW ARCHITECTS, INC. UNAUTHORIZED USE IS PROHIBITED


DATE: 4/16/25

DRAWN BY: Author JOB NO: 2319 SCALE: As indicated

PARTITION & CEILING **TYPES**

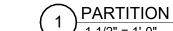

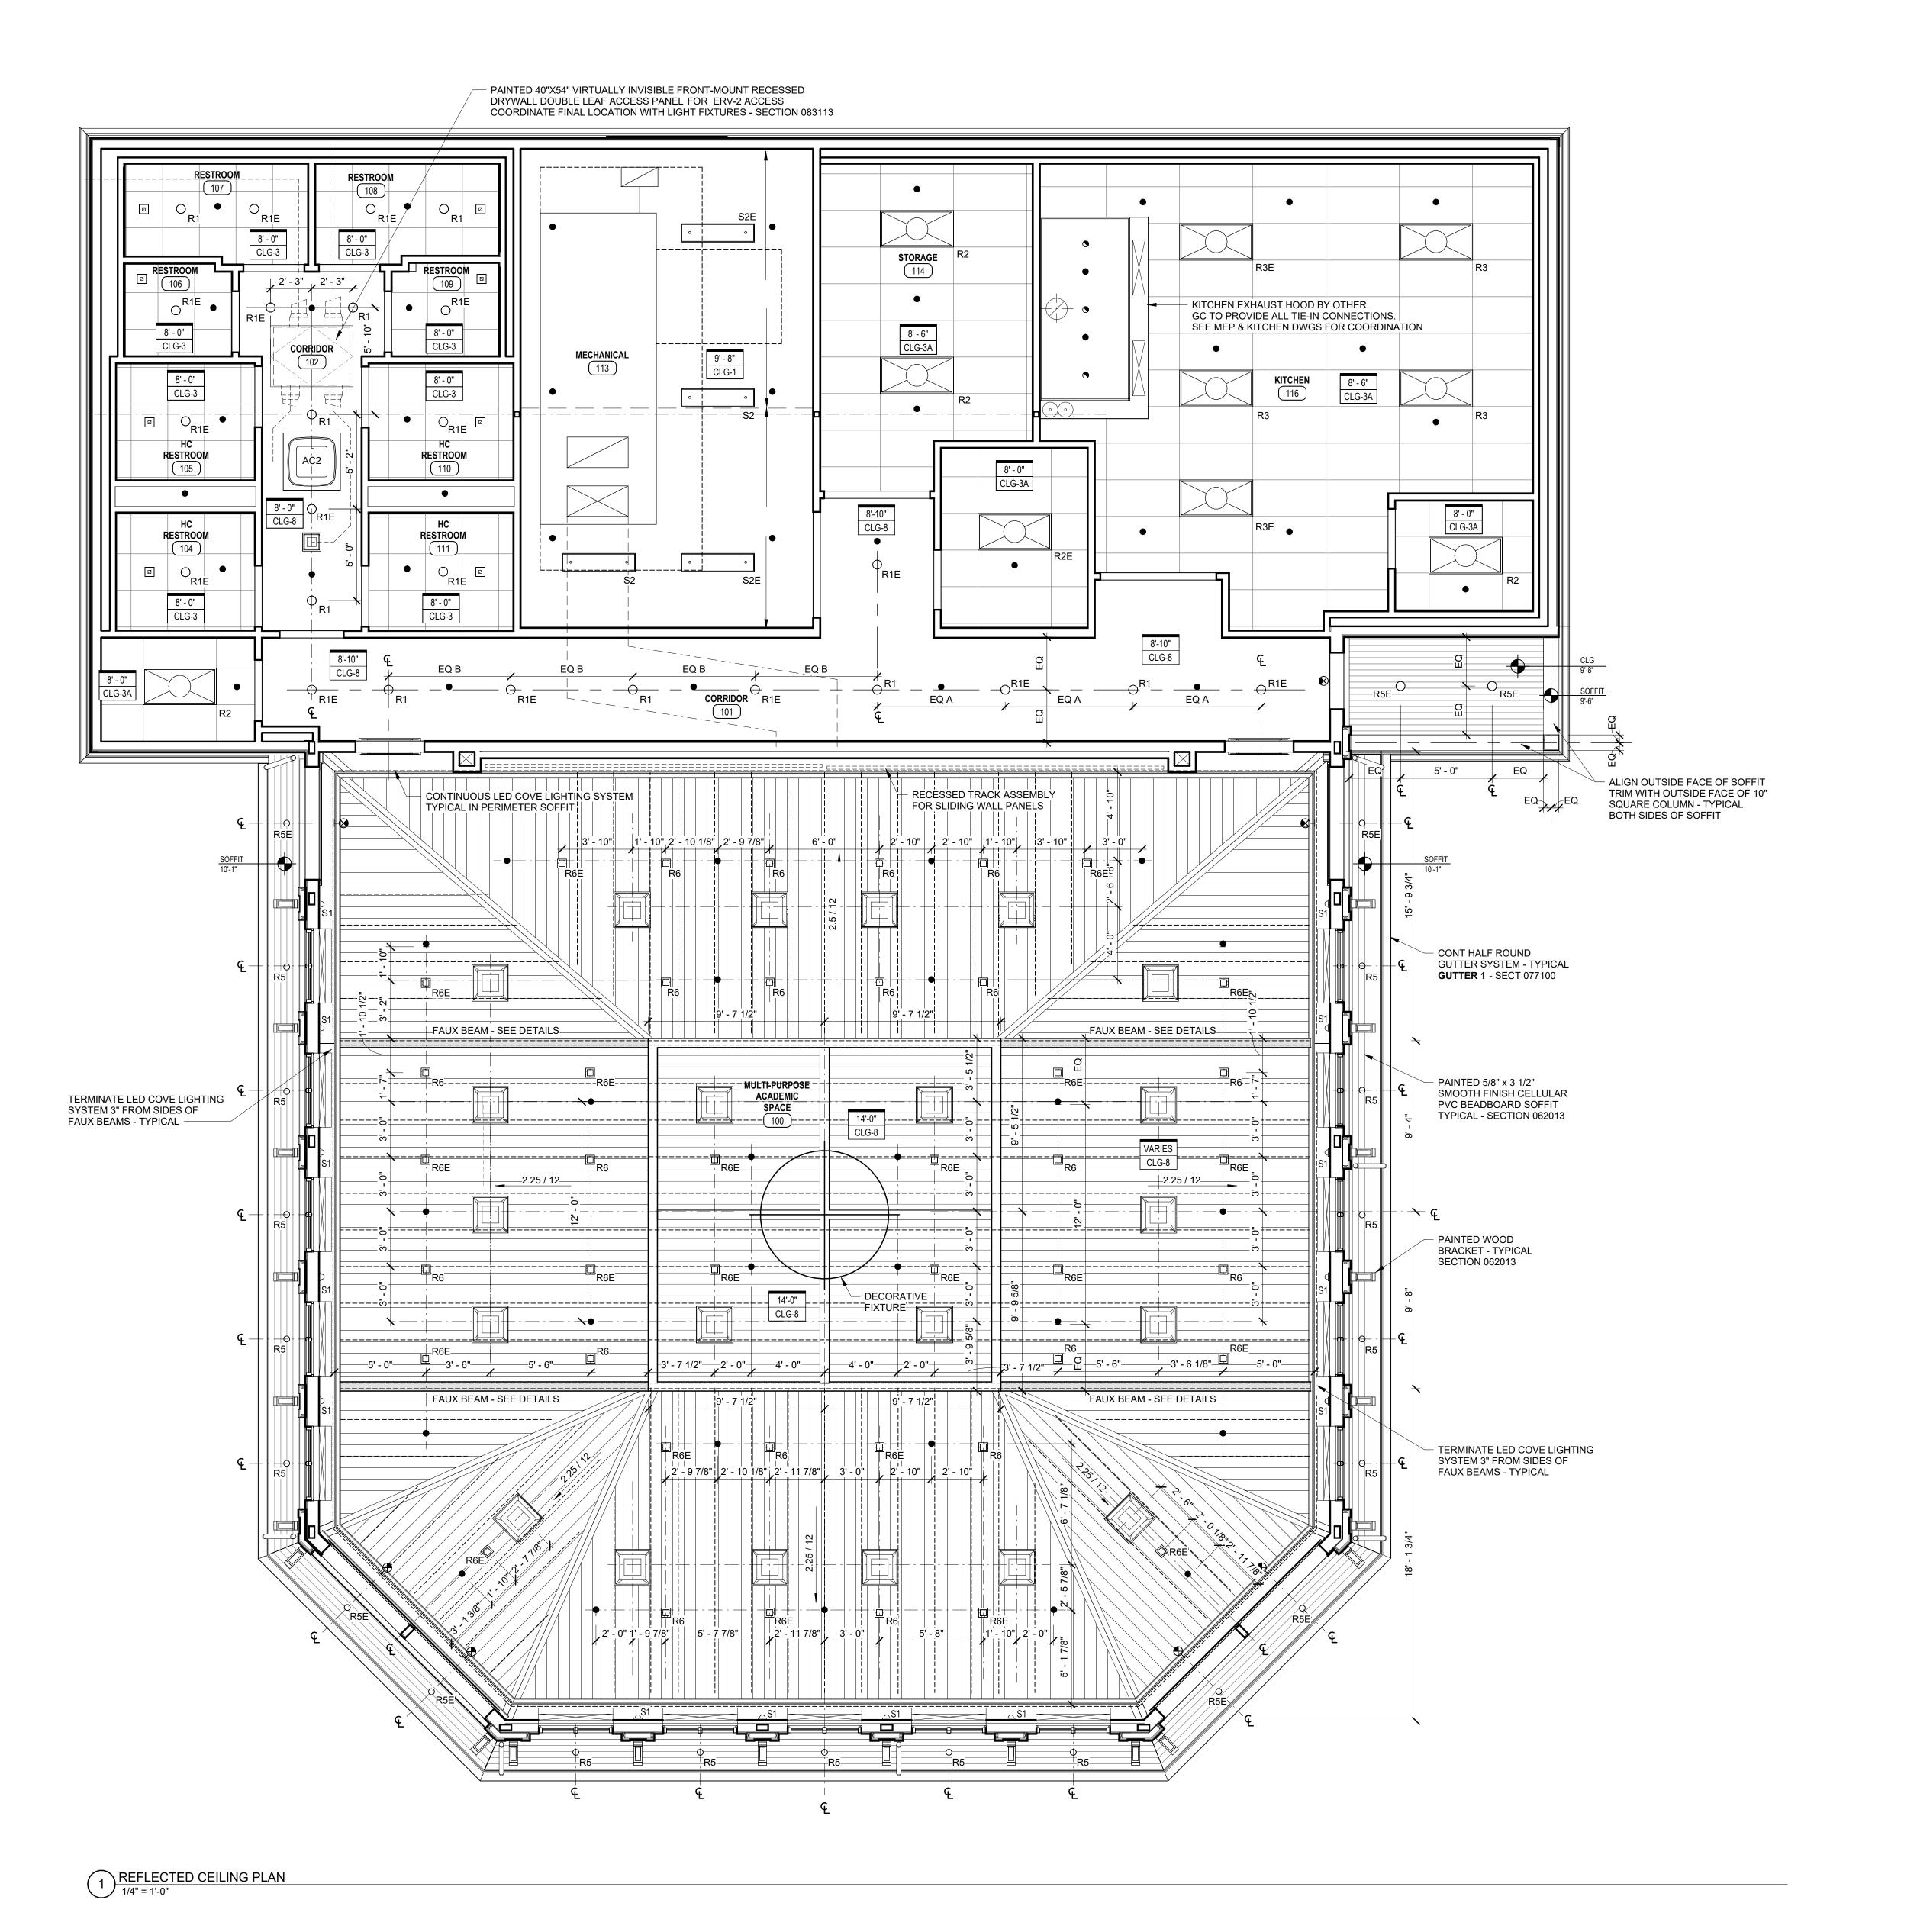

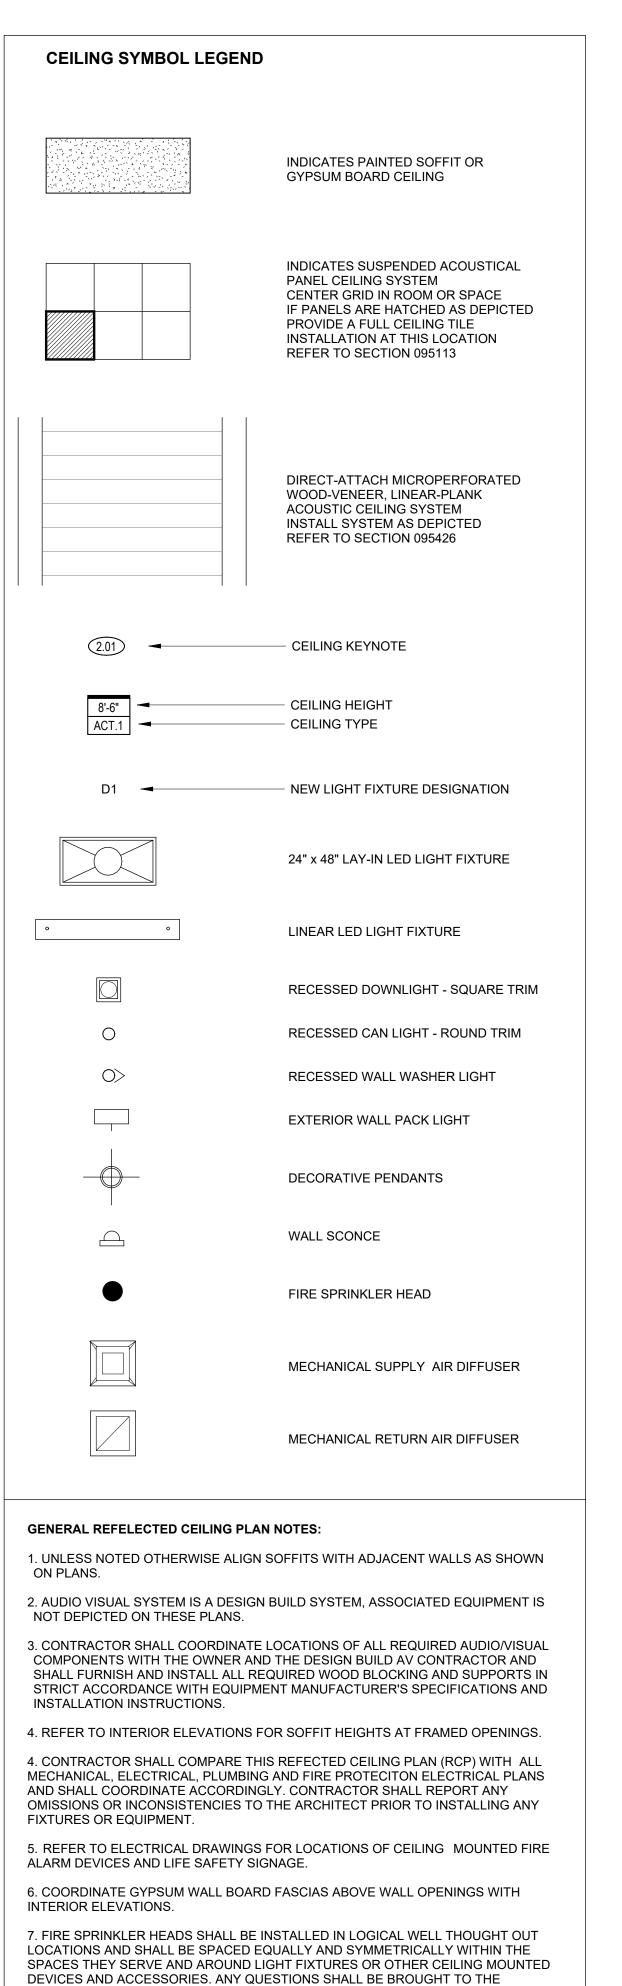

ATTENTION OF THE ARCHITECT PRIOR TO INSTALLING ANY EQUIPMENT.

9. REFER TO DRAWING SHEET A800 FOR CEILING TYPES & DETAILS

WHICH THEY OCCUR.

CEILING SYMBOLS & NOTES


1/4" = 1'-0"

8. CONTRACTOR SHALL VERIFY THAT ACCESS PANELS OF TYPE SPECIFIED ARE

INSTALLED IN NON-ACCESSIBLE TYPE CEILINGS WHERE SERVICE OR ADJUSTMENT TO MECHANICAL, PLUMBING, OR ELECTRICAL ITEMS MAY BE REQUIRED. ACCESS

PANELS SHALL BE THE FIRE RATED TYPE EQUAL TO THE RATING OF THE CEILING IN



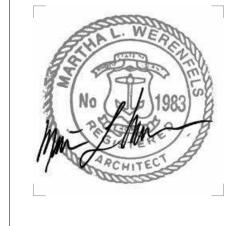



NEW STUDENT CENTER "PAPITTO" PAVILLION

NEWPORT, RHODE ISLAND

SALVE REGINA UNIVERSITY

NO DATE DESCRIPTION

NO DATE DESCRIPTION

© COPYRIGHT 2025 DBVW ARCHITECTS, INC. UNAUTHORIZED USE IS PROHIBITED

DATE: 4/16/25

DRAWN BY: Author

JOB NO: 2319


SCALE: 1/4" = 1'-0"

REFLECTED CEILING
PLAN

A901

Sheet 7 of 8


1 FLOOR FINISH PLAN
1/4" = 1'-0"

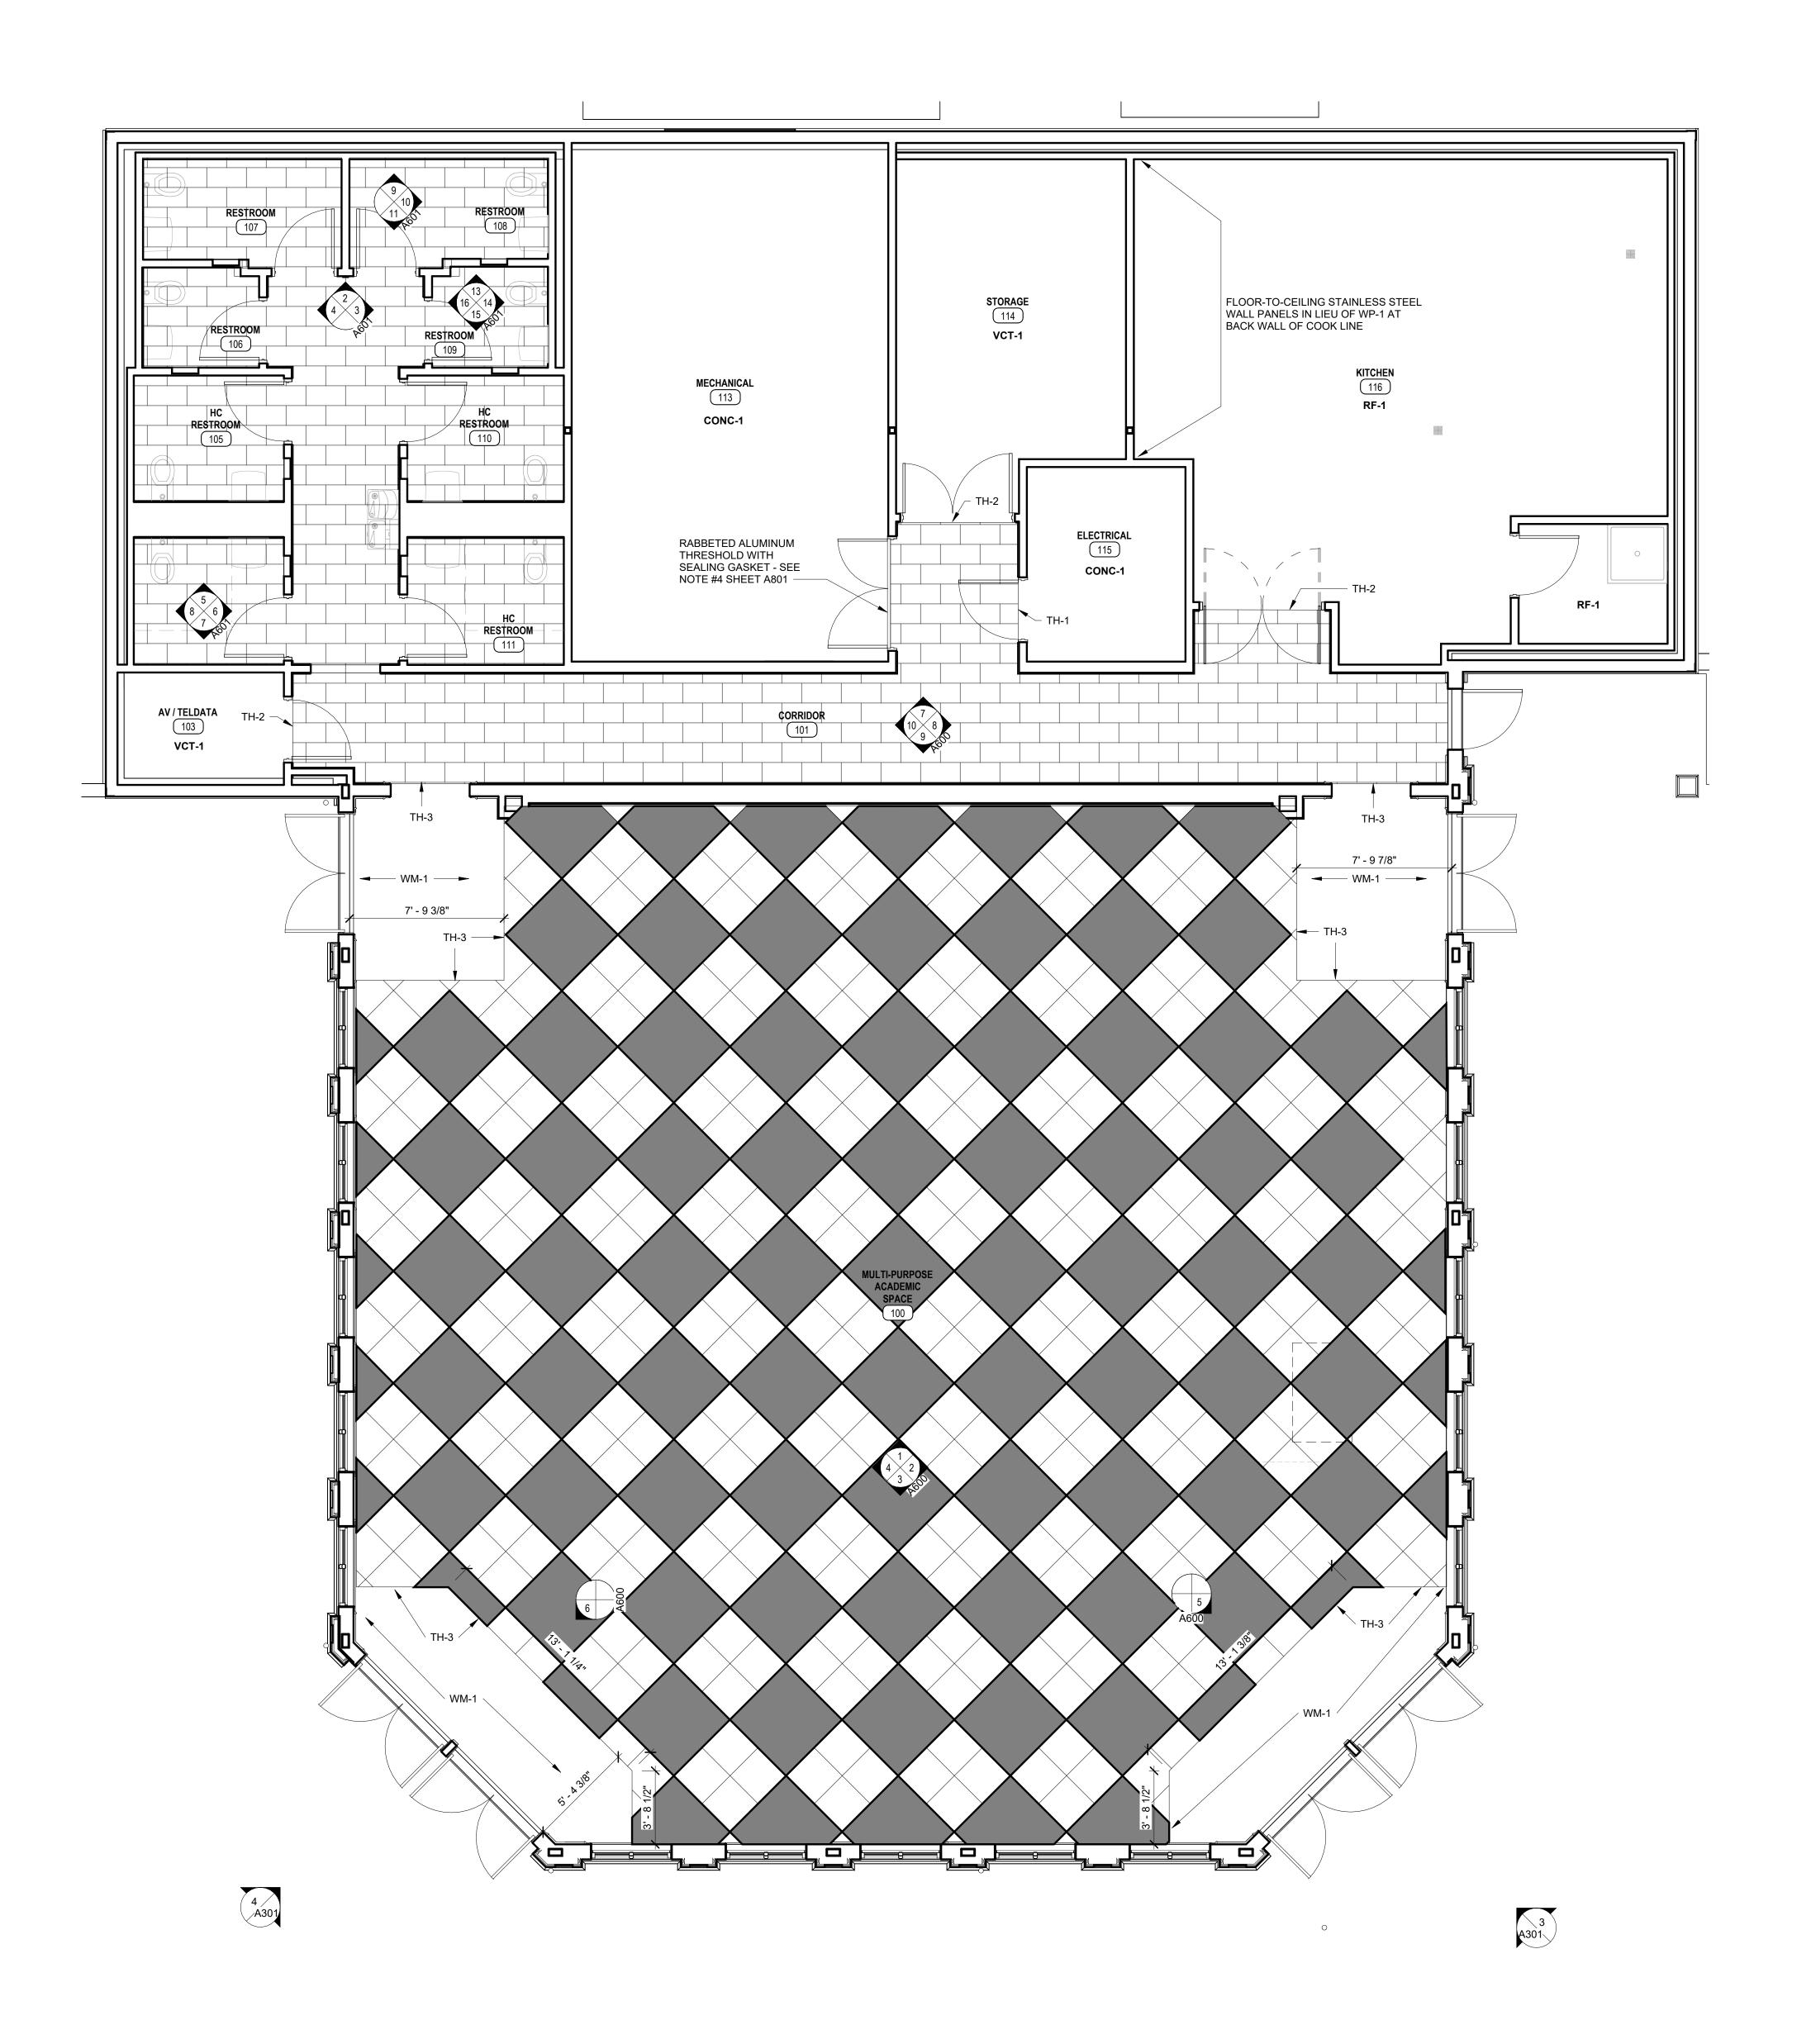

	FINISH LEGEND					
TYPE	DESCRIPTION	CONTACT	COMMENTS			
CONC-1	SEALED CONCRETE	CONTRACTOR	BACK OF HOUSE			
PT-1	SHERWIN WILLIAMS SW7010 WHITE DUCK	-	GENERAL WALL			
PT-2	SHERWIN WILLIAMS SW7036 ACCESSIBLE BEIGE	-	TRIM			
PT-3	SHERWIN WILLIAMS SW 7010 WHITE DUCK	-	CEILING AS INDICATED			
PT-4	SHERWIN WILLIAMS	-	-			
RF-1	ALTRO CLASSIC 25 -TRUFFLE, WITH INTREGAL BASE	MIKE NEWELL 617 851-8951	KITCHEN FLOORING			
T-1	DAL TILE PORTFOLIO PORCELAIN 24X24, COLOR: CHOCOLATE MATTE ,SEE FLOOR PATTERN PLAN FOR LAYOUT, GROUT: TBD	PAULA TOSTI 978.835.7793	EVENT SPACE			
T-1A	DAL TILE PORTFOLIO PORCELAIN 24X24 COLOR:NOCE MATTE, SEE FLOOR PATTERN PLAN FOR LAYOUT, GROUT TBD	PAULA TOSTI 978.835.7793	EVENT SPACE (DARKER COLOR IN PLAN)			
T-2	DAL TILE PORTFOLIO PORCELAIN 12X24, COLOR: CHOCOLATE MATTE, STAGGERED LAYOUT, GROUT : TBD	PAULA TOSTI 978.835.7793	BACK HALL AND TOILET ROOMS FLOOR TILE			
T-2A	DAL TILE PORTFOLIO PORCELAIN COVE BASE, CHOCOLATE MATTE	PAULA TOSTI 978.835.7793	TOILET ROOM BASE TILE , SEE ELEVATIONS			
T-3	BEST TILE MARTINI 2X6" CERAMIC WALL TILE, COLOR:MINT GLOSSY, STACK BOND VERTICALLY. GROUT TBD	CHERYL WINTERS 781.915.8090	TOILET ROOM WALL TILE (MINT GREEN)			
T-4	BEST TILE MARTINI 2X6" CERAMIC WALL TILE, COLOR:DENIM GLOSSY , STACK BOND VERTICALLY . GROUT TBD	CHERYL WINTERS 781.915.8090	TOILET ROOM WALL TILE (BLUE)			
T-5	BEST TILE MARTINI 2X6" CERAMIC WALL TILE, COLOR: GREEN GLOSSY, STACK BOND VERTICALLY. GROUT TBD	CHERYL WINTERS 781.915.8090	TOILET ROOM WALL TILE (GREEN)			
TH-1	SCHLUTER RENO RAMP- ALUMINUM FINISH	MARK WALSH617.599.6153	TILE TO CONTRACT, SEE DETAIL			
TH-2	SCHLUTER -ALUMINUM FINISH	MARK WALSH617.599.6153	TILE TO RESILIENT. SEE DETAIL			
TH-3	SCLUTER- ALUMINUM FINISH	MARK WALSH617.599.6153	CARPET TO TILE, SEE DETAIL			
VCT-1	TARKETT VCT II, , COLOR- SHOOTING STAR	JOHN MCNULTY 617.293.7131	BACK OF HOUSE PER PLAN			
WB-1	7.5" PAINTED WOOD BASE, SEE PROJECT SPECS FOR MORE INFORMATION	CONTRACTOR	MAIN EVENT SPACE			
WB-2	5.5" PAINTED WOOD BASE, PAINTED PER SCHEDULE	CONTRACTOR	CORRIDOR SPACES			
WB-3	TARKETT 4" VINYL BASE: COLOR:	JOHN MCNULTY 617.293.7131	BACK OF HOUSE SPACES			
WB-4	6" INTREGAL BASE OF RF-1	-	KITCHEN			
WC-1	CUSTOM PRINTED VINYL TYPE 2 WALLCOVERING	CINDY CEDRONE 781.320.2972	EVENT SPACE			
WM-1	SHAW CONTRACT ALL ACCESS PATH 24X24 TILE, MONOLITHIC INSTALL	CHACE PURSLEY 401.600-1055	WALK OFF AT ENTRANCE			
WP-1	INPRO PALLADIUM RIGID WALL PROTECTION W/ MATCHING TRIM. COLOR:BISCOTTI	STACY SNELL 857.292.2116	KITCHEN WALLS BASE TO CEILING			

FINISH SCHEDULE								
ROOM#	ROOM NAME	FLOOR	BASE	WALL	COMMENTS			
RST FLOO	DR							
100	MULTI-PURPOSE ACADEMIC SPACE	T-1/WM-1	WB-1	PT-1				
101	CORRIDOR	T-2	WB-2	PT-1				
102	CORRIDOR	T-2	WB-2	PT-1				
103	AV / TELDATA	VCT-1	WB-3	PT-1				
104	HC RESTROOM	T-2	T-2A	PT-1				
105	HC RESTROOM	T-2	T-2A	PT-1				
106	RESTROOM	T-2	T-2A EXCEPT WET WALL	T-3				
107	RESTROOM	T-2	T-2A EXCEPT WET WALL	T-4				
108	RESTROOM	T-2	T-2A EXCEPT WET WALL	T-5				
109	RESTROOM	T-2	T-2A EXCEPT WET WALL	T-3				
110	HC RESTROOM	T-2	T-2A EXCEPT WET WALL	T-4				
111	HC RESTROOM	T-2	T-2A EXCEPT WET WALL	T-5				
112	CORRIDOR	T-2	WB-2	PT-1				
113	MECHANICAL	CONC-1	WB-3	PT-1				
114	STORAGE	VCT-1	WB-3	PT-1				
115	ELECTRICAL	CONC-1	WB-3	PT-1				
116	KITCHEN	RF-1	WB-4	WP-1	SEE NOTES ON FINISH PLAN			
117	CUSTODIAL	RF-1	WB-4	PT-1				

FINISH SCH	EDULE NOTES			
	TO INTERIOR PAINT SYST AL INFORMATION & REQ		PROJECT SPECIFICATI	ONS
2. REFER TO FIN	NISH PLANS FOR PAINT A	ACCENT COLOR	(PT-#) LOCATIONS.	
3. REFER TO RE	FLECTED CEILING PLAN	S FOR CEILING	TYPES.	
4. ALL WALLS AI	RE TO BE PAINTED COLO	OR PT-1 UNLESS	OTHERWISE NOTED.	
5. ALL INTERIOR	R DOORS TO BE PAINTED	PT-2 UNLESS C	THERWISE NOTED.	
6. ALL INTERIOR	R WOOD TRIM TO BE AIN	TED PT-2 UNLES	S OTHERWISE NOTED.	
INTERIOR DES	NTERIOR PAINT FINISH C IGNER FOR FINAL APPRO OF ANY INFORMATION P	OVAL PRIOR TO	APPLICATION OF ANY F	

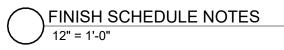







NEW STUDENT CENTER "PAPITTO" PAVILLION

NEWPORT, RHODE ISLAND

SALVE REGINA UNIVERSITY

© COPYRIGHT 2025
DBVW ARCHITECTS, INC.
UNAUTHORIZED USE IS PROHIBITED

DATE: 4/16/25

DRAWN BY: Author

JOB NO: 2319


SCALE: As indicated


FLOOR FINISH PLAN

1201





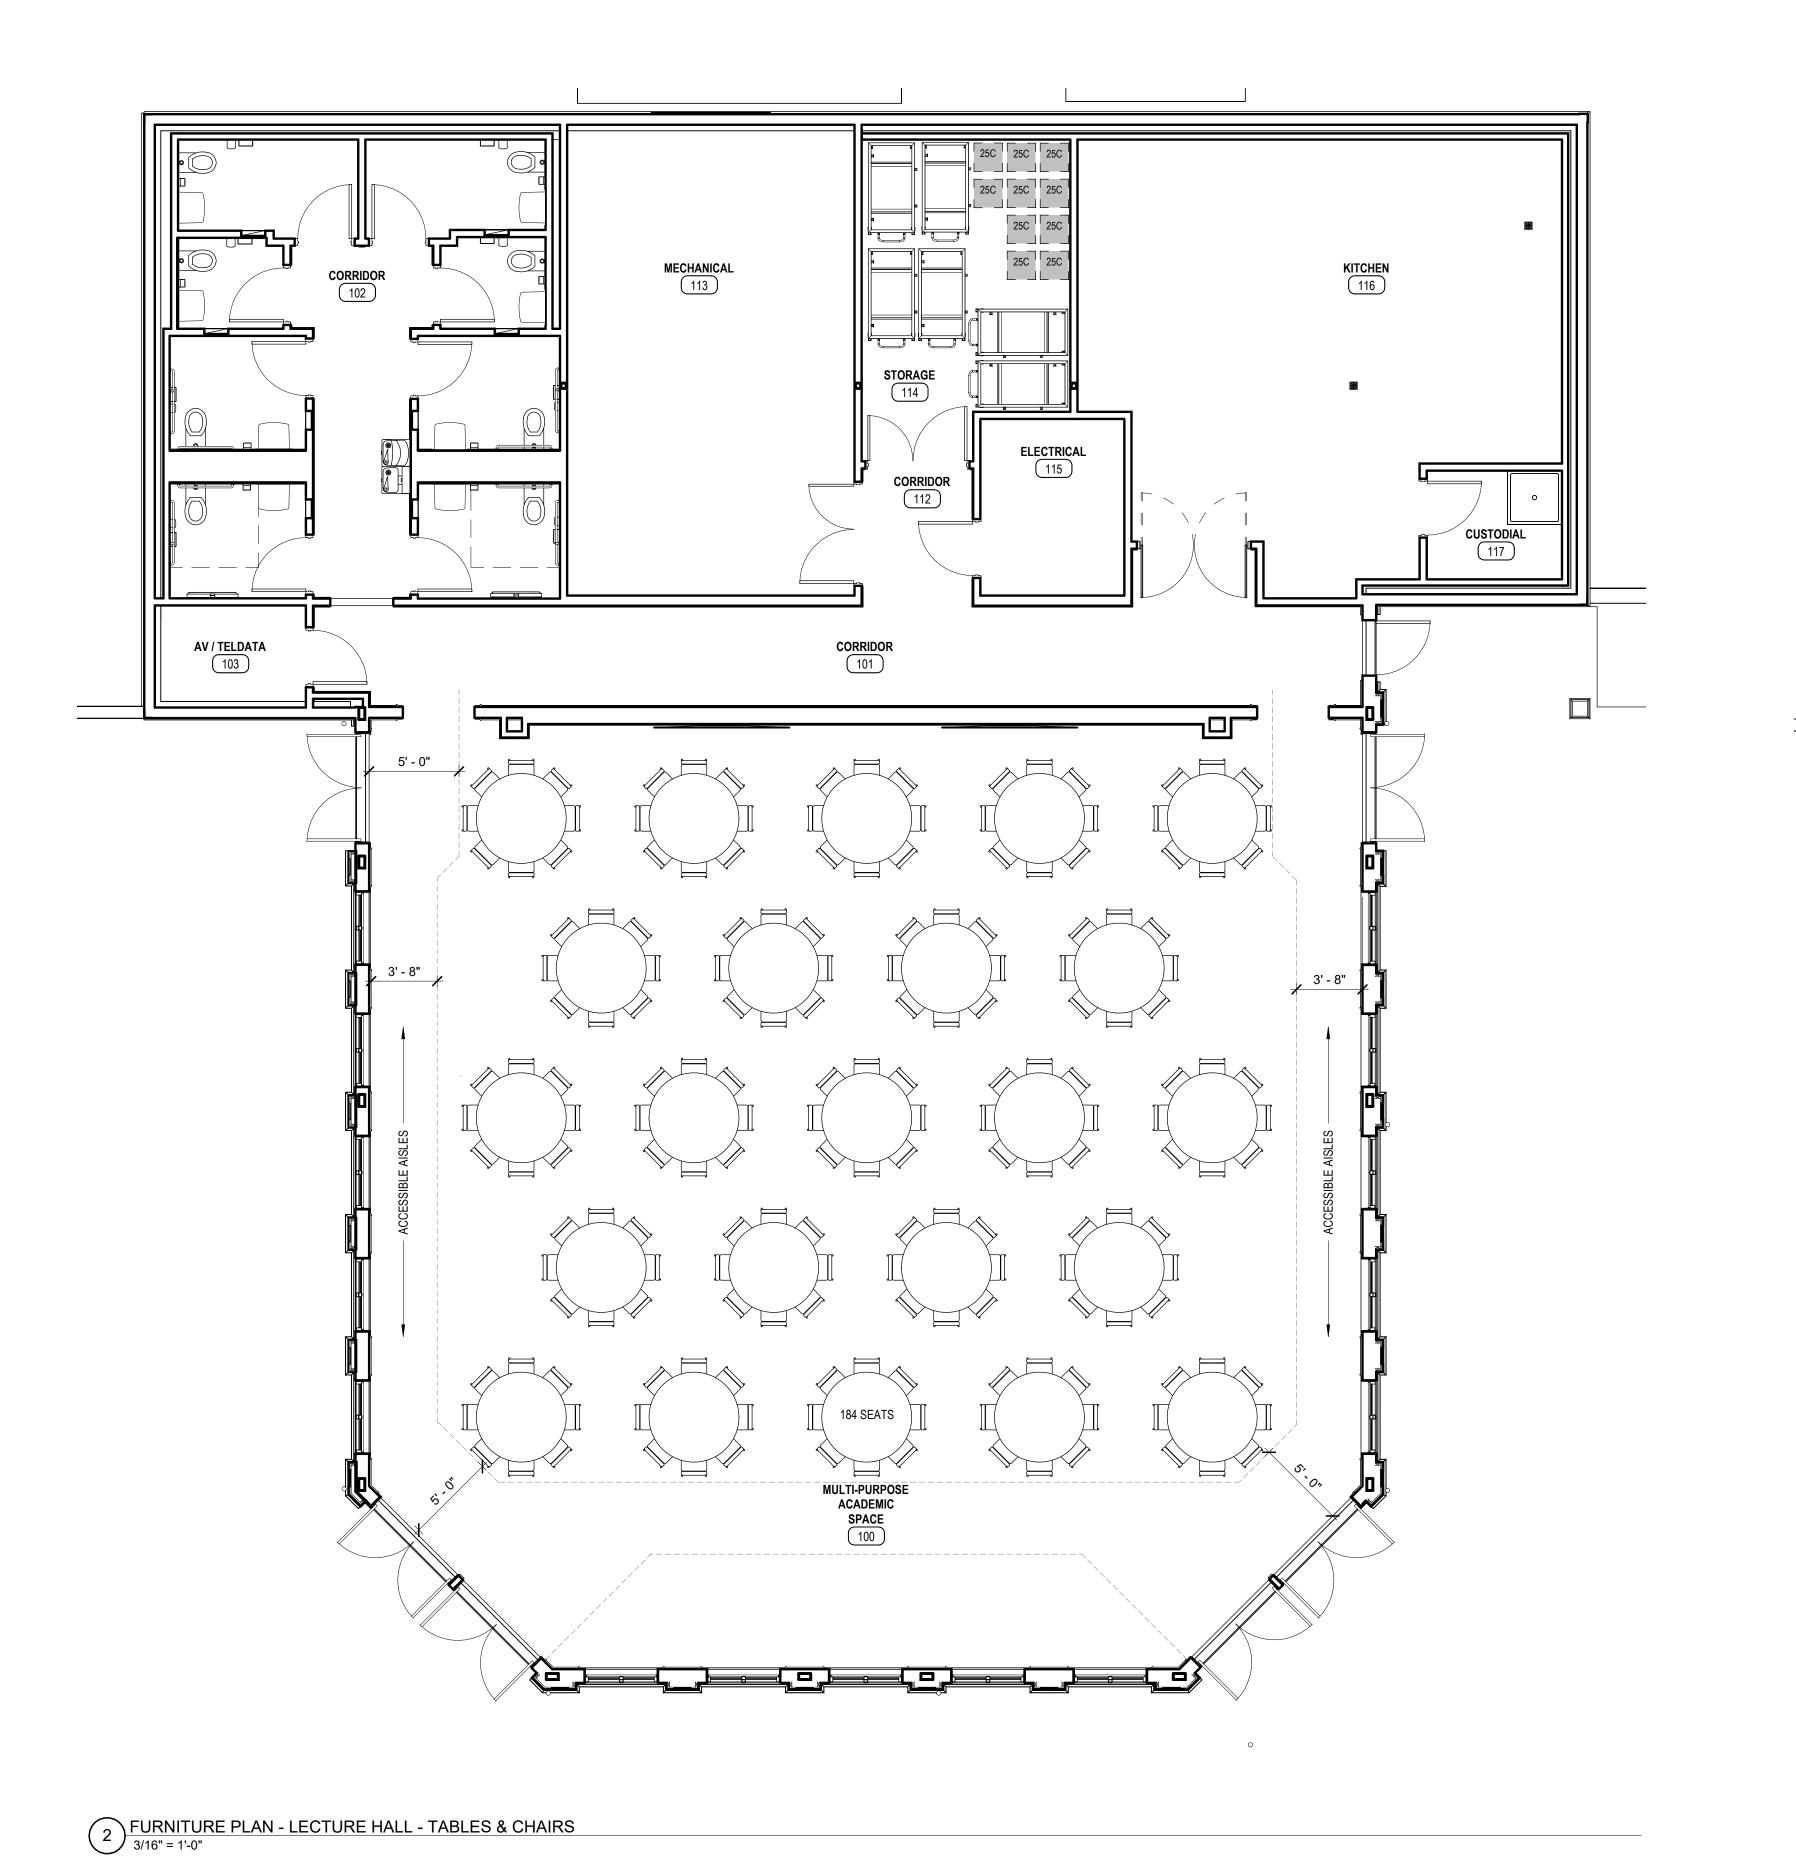

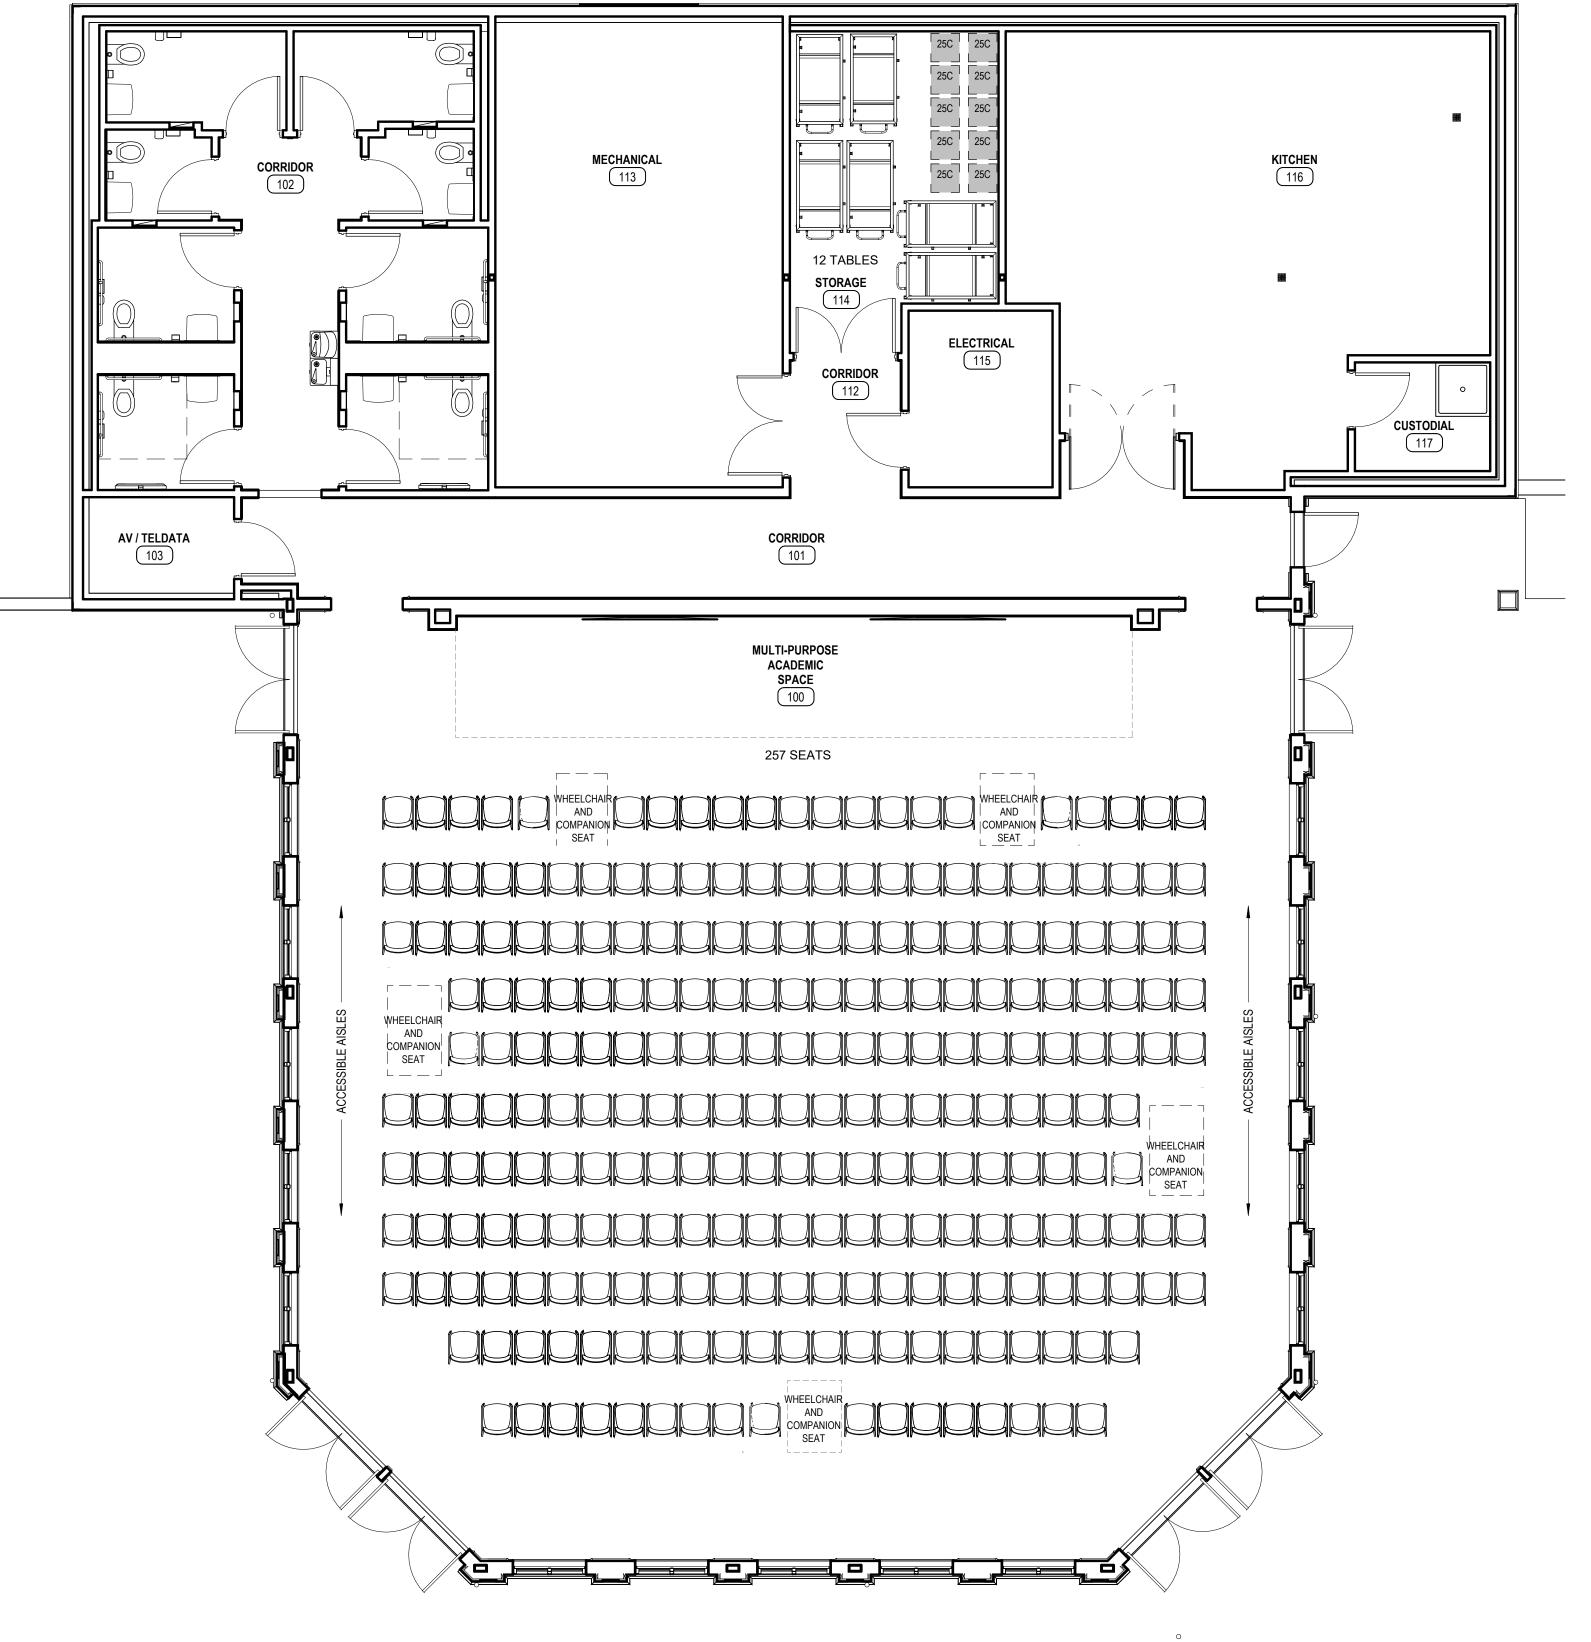

1 FURNITURE PLAN - LECTURE HALL - CHAIRS ONLY 3/16" = 1'-0"

NEW STUDENT CENTER "PAPITTO" PAVILLION

SALVE REGINA UNIVERSITY

NEWPORT, RHODE ISLAND

SALVE REGINA UNIVERSITY

NO DATE DESCRIPTION

© COPYRIGHT 2025
DBVW ARCHITECTS, INC.
UNAUTHORIZED USE IS PROHIBITED

DATE: 4/16/25

DRAWN BY: Author

JOB NO: 2319

SCALE: 3/16" = 1'-0"

FURNITURE PLAN

I301